APPLICATION FOR BUILDING PERMIT

6 CLOVIS AVENUE, HALIFAX, NOVA SCOTIA, B3P 1J2

2023.03.21



LIST OF DRAWINGS

\ 001	NOTES
\100	EXISTING SITE PLAN
\101	PROPOSED SITE PLAN
102	PROPOSED FOUNDATION PLAN
103	PROPOSED FLOOR PLAN - LEVEL 0
104	PROPOSED FLOOR PLAN - LEVEL 1
105	PROPOSED FLOOR PLAN - LEVEL 2
106	PROPOSED ROOF PLAN
1201	PROPOSED SOUTH ELEVATION
1202	PROPOSED WEST ELEVATION
1203	PROPOSED NORTH ELEVATION
1204	PROPOSED EAST ELEVATION
\ 301	PROPOSED SECTION
\ 302	PROPOSED SECTION 2
4601	WINDOW SCHEDULE
\602	DOOR SCHEDULE


NEW TWO - FAMILY DWELLING AT 6 CLOVIS AVENUE

ARCHITECTURAL DRAWINGS BY:



GENERAL NOTES:

- THE CONTRACTOR SHALL EXAMINE ALL DRAWINGS AND CHECK ALL DIMENSIONS ON SITE, AGAINST SITE CONDITIONS AND REPORT ANY DISCREPANCIES TO THE ARCHITECT/DESIGNER AND ENGINEER BEFORE
- PROCEEDING WITH WORK
- ALL WORKERS AND MATERIALS SHALL CONFORM TO THE CURRENT NATIONAL BUILDING CODE OF CANADA; AS WELL AS ALL REGIONAL AND PROVINCIAL BUILDING CODES AND REGULATION.
- CLIENT/GENERAL CONTRACTOR RESPONSIBLE FOR CHECKING CODE COMPLIANCY
- ALL CONSTRUCTION TO BE CARRIED OUT IN ACCORDANCE WITH THE NOVA SCOTIA OCCUPATIONAL HEALTH AND SAFETY ACT.
- ALL CONSTRUCTION SHALL BE CARRIED OUT IN ACCORDANCE WITH ALL LOCAL CODES AND AUTHORITIES HAVING JURISDICTION.
- NO VARIATIONS OR MODIFICATIONS TO WORK SHOWN SHALL BE IMPLEMENTED WITHOUT PRIOR APPROVAL OF THE GENERAL CONTRACTOR.
- ALL PERMITS PERTAINING TO THE WORK SHALL BE APPLIED AND PAID FOR BY THE GENERAL CONTRACTOR OR HIS/HER SUBCONTRACTOR UNLESS NOTIFIED OTHERWISE IN WRITING BY THE OWNER. THE PRIME CONSULTANT, DESIGNER OR GENERAL CONTRACTOR IS RESPONSIBLE FOR COORDINATING ENGINEERING SITE REVIEWS. A MINIMUM OF 2 DAYS NOTICE IS REQUIRED FOR SITE REVIEWS. TYPICAL SITE
- REVIEW TO INCLUDE FOUNDATIONS AND FRAMING UNLESS OTHERWISE NOTED. ENGINEER SITE REVIEWS DO NOT TAKE THE PLACE OF INSPECTIONS BY LOCAL BUILDING OFFICIALS.
- CONTRACTOR SHALL MAKE GOOD ON ANY DAMAGE OR INJURY TO HIS/HER WORK AND TO THE PROPERTY OF THE OWNER RESULTING FROM THE LACK OF REASONABLE PROTECTIVE PRECAUTIONS.
- CONTRACTOR RESPONSIBLE FOR JOB SITE CLEAN-UP AND TO FOLLOW LOCAL RECYCLING BY-LAWS.
- DIMENSIONS TO TAKE PRECEDENCE OVER SCALE.
- DO NOT SCALE DRAWING. IF A DIMENSION IS REQUIRED, BUT NOT SHOWN PLEASE CONTACT THE DESIGNER. ALL PREVIOUS ISSUES OF THIS DRAWING ARE SUPERCEDED.
- SHOULD THIS DRAWING(s) BE TRANSFERRED VIA EMAIL. THE DESIGNER SHALL NOT TAKE RESPONSIBILITY FOR CHANGES OCCURING DURING OR AFTER TRANSFER OF INFORMATION.
- ALL NOTES AND DIMENSIONS ARE TO BE VERIFIED BY THE CONTRACTOR PRIOR TO CONSTRUCTION.
- ANY ERRORS OR OMISSIONS SHALL BE REPORTED TO THE DESIGNER, WHO WILL REVISE AND ISSUE NEW DRAWINGS AS NECESSARY PRIOR TO ANY CONSTRUCTION. ALL INSTALLATIONS SHALL BE INSTALLED ACCORDING TO MANUFACTURER'S SPECIFICATIONS.
- SOIL BEARING CAPACITY SHALL BE VERIFIED.
- SUB-BASE UNDER SLAB ON GRADE SHALL BE COMPACTED TO 100% STANDARD PROCTOR DENSITY. COMPACTION SHALL BE VERIFIED.
- ALL CONCRETE TO BE 3000PSI MIX @ 28 DAYS (MIN) UNLESS NOTED OTHERWISE.
- ALL CONCRETE FOOTINGS MUST BE LOCATED BELOW THE FROST-LINE AND REST ON UNDISTURBED SOIL. ANY OVER-EXCAVATION TO BE FILLED WITH CONCRETE.
- FOUNDATION CONTRACTOR TO REFER TO FLOOR PLANS FOR ALL WINDOW AND DOOR SIZES AND LOCATION, BEAM POCKETS ETC. PRIOR TO INSTALLATION. BACKFILLING AGAINST WALLS ON ONE SIDE ONLY SHALL NOT BE STARTED UNTIL TEMPORARY BRACING AND FLOOR SLABS PROVIDING SUPPORT ARE IN PLACE.
- VAPOUR BARRIERS TO BE INSTALLED AS CONTINUOUS. CAULK AND SEAL ALL JOINTS AND INTERSECTIONS (I.E ELECTRICAL BOXES, STACKS, WINDOWS AND DOORS, ETC). ALL WINDOW AND DOOR SIZES ARE APPROXIMATE ONLY. CONTRACTOR TO MEASURE ACTUAL ROUGH OPENINGS OF ALL WINDOWS ON THE SITE PRIOR TO ORDERING OF WINDOWS.
- VENTILATION REQUIREMENTS TO BE DONE BY CERTIFIED INSTALLER TO MEET N.B.C. SPECIFICATIONS.
- OWNER TO VERIFY MATERIALS, STYLES AND COLOURS.
- CONTRACTOR TO CONFIRM ALL DIMENSIONS, ELEVATIONS, AND LOCATIONS AND REPORT ANY DISCREPENSIES TO THE ENGINEER.
- ELECTRICAL AND MECHANICAL CONTRACTORS TO COORDINATE, SUPPLY, AND INSTALL ALL PIPING AND PENETRATIONS (BY THIRD PARTY).
- ALL ROOF STRUCTURE ARE SPECIFIED BY ENGINEER
- ALL INTERIOR WALL FINISHES ARE AS SPECIFIED BY OWNER
- ALL FLOOR FINISHES TO BE DETERMINED BY OWNER
- GRADE LINE COULD CHANGE ACCORDING TO SOIL NATURE
- ALL DIMENSIONS MUST BE VERIFIED ON SITE, DO NOT SCALE OFF DRAWINGS. PLANS TAKE PRECEDENT OVER ELEVATIONS. IN ABSENCE OF DIMENSIONS,
- OR IF DISCREPANCIES EXIST, CONSULT WITH 360 CAD, ALL MINIMUM DIMENSIONS ARE TO COMPLY WITH THE NBCC2015
- HRV VENTILATION SYSTEM TO BE INSTALLED PER NBCC 2010, NSBC 2020
- ALL EXTERIOR WALLS TO BE INSULATED TO A MINIMUM R24
- ALL SLABS TO BE INSULATED WITH MINIMUM R14 RIGID FOAM INSULATION TO CONFORM TO 9.36 NBCC 2015
- ALL WINDOWS AND DOORS ARE TO BE FLASHED AS REQUIRED NY NBCC 2015
- ALL CONSTRUCTION TO BE IN CONFORMANCE WITH THE LATEST VERSION OF NBCC, NPCC, NSBC.

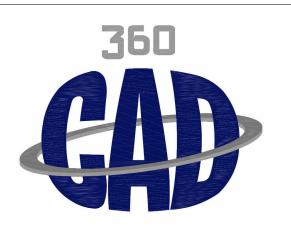

"Where Imagination & Reality Collide"

360 CAD SERVICES INC.

GENERAL NOTES:

NOT FOR CONSTRUCTION

ALL DIMENSIONS TO BE VERIFIED ON SITE AND CONFIRMED BY CONTRACTOR.

DO NOT SCALE THIS DRAWING.

REV	DESCRIPTION	DATE
1	ISSUED FOR REVIEW	2023.03.15

ISSUED FOR BUILDING PERMIT


DRAWING TITLE:


NOTES

PROJECT:

NEW TWO - FAMILY DWELLING

VMZ
MS
2023.03.21
DWG:
A001

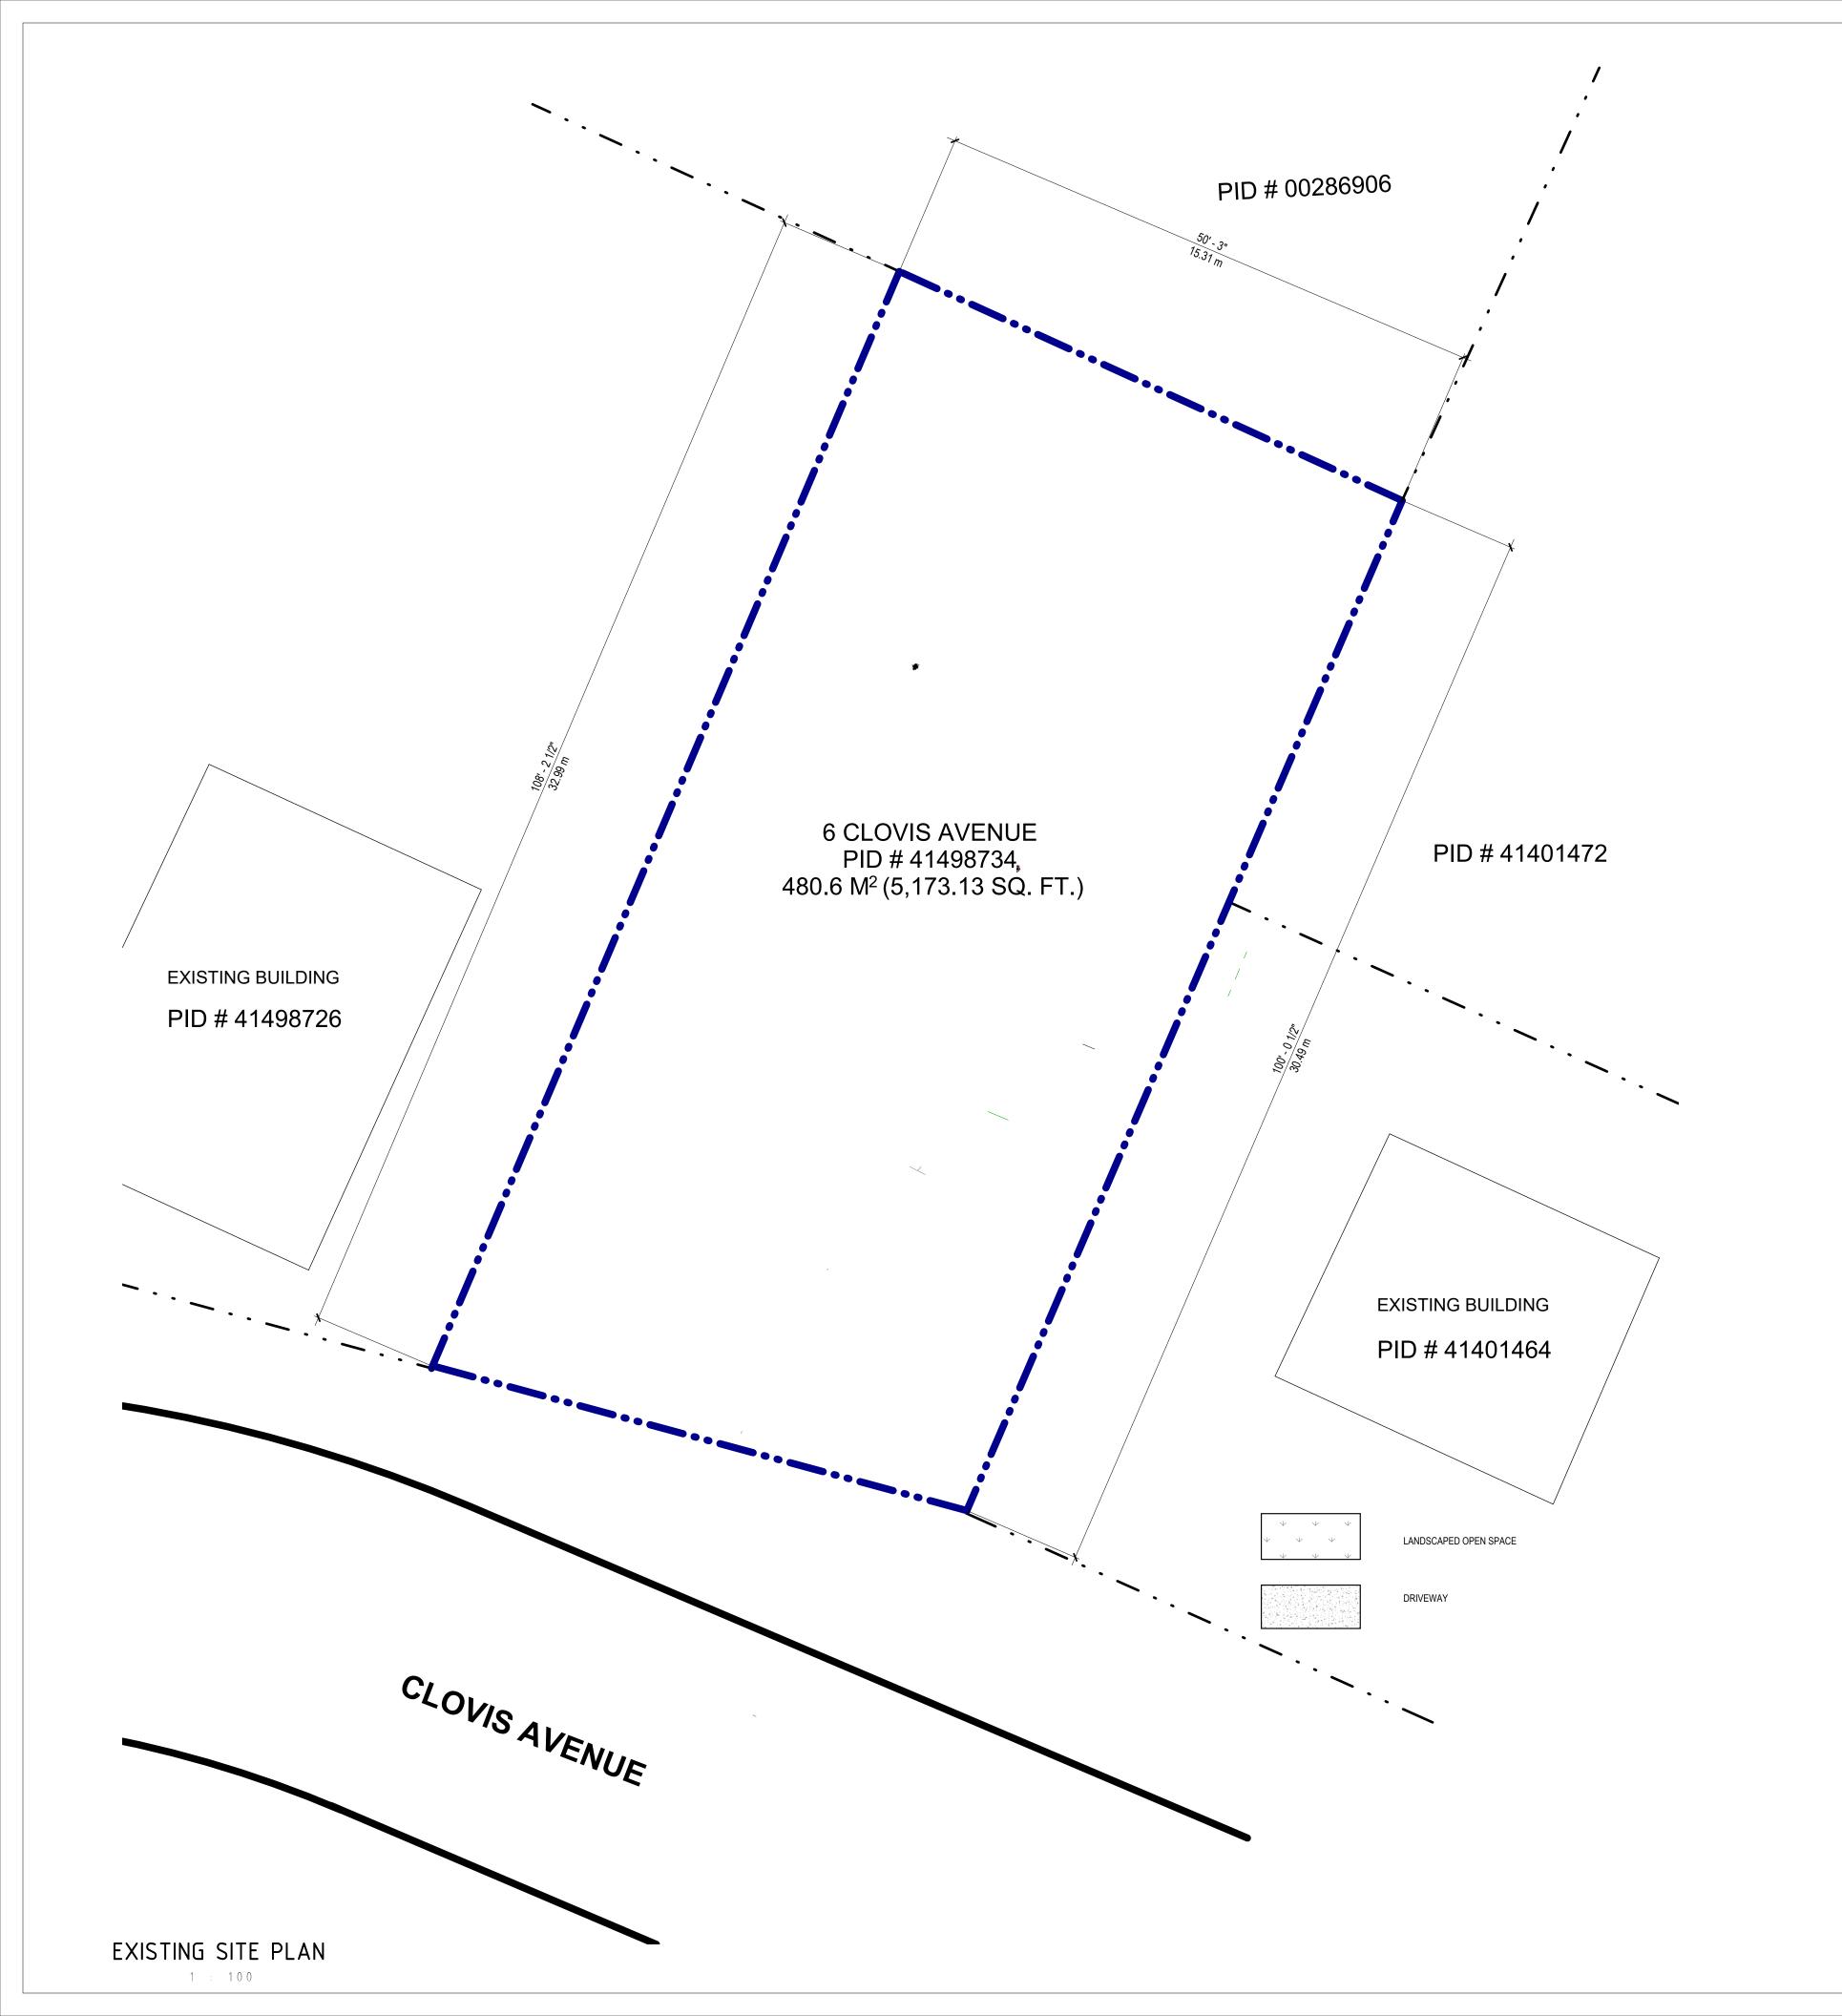

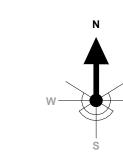



GENERAL NOTES:

NOT FOR CONSTRUCTION

ALL DIMENSIONS TO BE VERIFIED ON SITE AND CONFIRMED BY CONTRACTOR.

DO NOT SCALE THIS DRAWING.

REV	DESCRIPTION	DATE
1	ISSUED FOR REVIEW	2023.03.15

ISSUED FOR BUILDING PERMIT

DRAWING TITLE:

EXISTING SITE PLAN

PROJECT:

NEW TWO - FAMILY DWELLING

6 CLOVIS AVENUE, HALIFAX, NOVA SCOTIA, B3P 1J2

DRAWN BY:	VMZ
CHECKED BY:	MS
DATE:	2023.03.21
CLIENT:	DWG:
	A 400
SCALE:	A100
1:100	

LEGEND:

SUBJECT PROPERTY LINE

— · · — ADJACENT PROPERTY LINE

LOT A INFORMATION:

PID: 41498734

CIVIC: 6 CLOVIS AVENUE, HALIFAX, NOVA SCOTIA, B3P 1J2


OWNER: AREA:


ZONE:

480.6 M² (5,173.13 SQ. FT.) R-2 ZONE, MAINLAND SOUTH AREA

SITE USAGE:

PROPERTY: 480.6 M² (5,173.13 SQ. FT.)

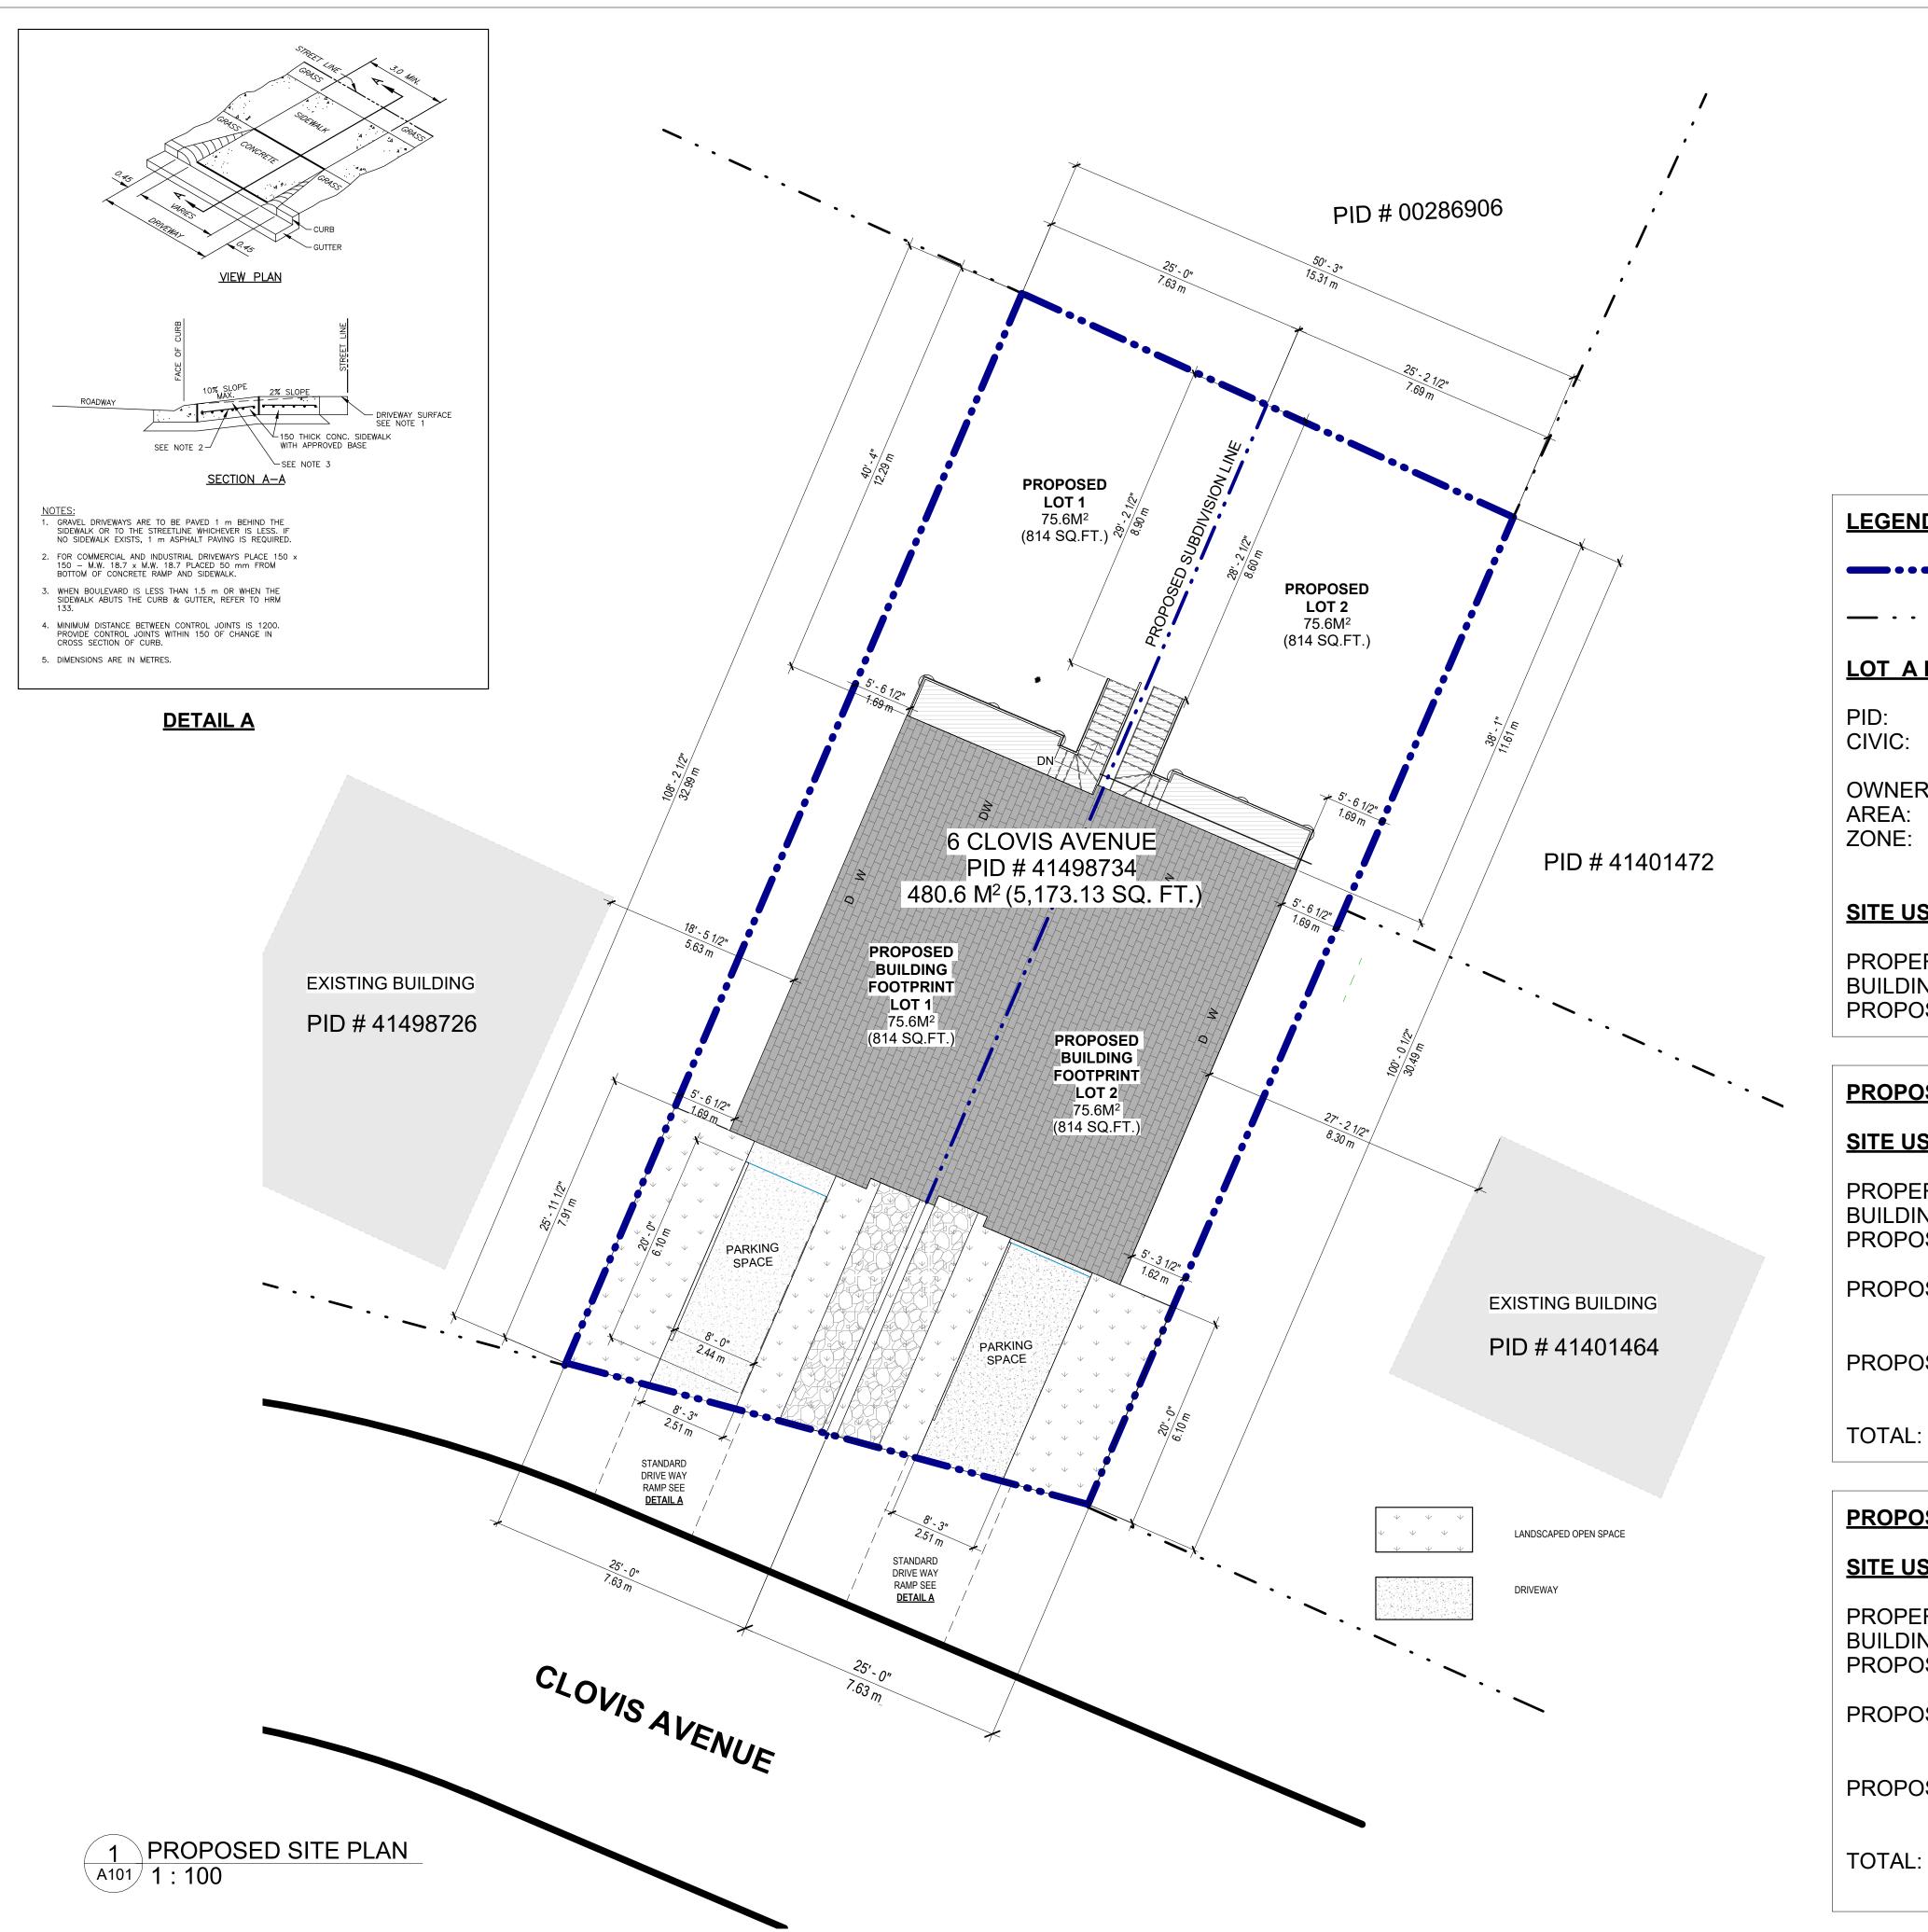

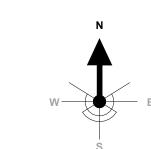



GENERAL NOTES:

NOT FOR CONSTRUCTION

ALL DIMENSIONS TO BE VERIFIED ON SITE AND CONFIRMED BY CONTRACTOR.

DO NOT SCALE THIS DRAWING.

LEGEND:

SUBJECT PROPERTY LINE

- - — ADJACENT PROPERTY LINE

LOT A INFORMATION:

41498734

6 CLOVIS AVENUE, HALIFAX,

NOVA SCOTIA, B3P 1J2

OWNER:

AREA: 480.6 M² (5,173.13 SQ. FT.)

ZONE: R-2 (TWO - FAMILY DWELLING)

ZONE, MAINLAND SOUTH AREA

SITE USAGE:

PROPERTY: 480.6 M² (5,173.13 SQ. FT.) 151.24M² (1,628 SQ.FT.) **BUILDING FOOTPRINT:**

PROPOSED LOT COVERAGE RATIO: 31.47%

PROPOSED LOT 1:

SITE USAGE:

PROPERTY: 242.74M²(2,612.85 SQ.FT.) **BUILDING FOOTPRINT:** 75.62M² (814 SQ.FT.)

PROPOSED LOT COVERAGE RATIO:

31.15%

PROPOSED LANDSCAPED OPEN SPACE: 67.26%

38.08M²(409.89 SQ.FT.)

PROPOSED DRIVEWAY SPACE:

32.74% 18.54M²(199.56 SQ.FT.)

56.62M²(609.45 SQ.FT.)

PROPOSED LOT 2:

SITE USAGE:

PROPERTY: 237.86M² (2,560.28 SQ.FT.) **BUILDING FOOTPRINT:** 75.62M²(814 SQ.FT.)

PROPOSED LOT COVERAGE RATIO:

31.79%

PROPOSED LANDSCAPED OPEN SPACE: 67.27%

34.16M²(367.74 SQ.FT.)

PROPOSED DRIVEWAY SPACE:

32.73% 16.62M²(178.88 SQ.FT.)

50.78M²(546.62 SQ.FT.)

DRA	WING TITLE:	
	ISSUED FOR BUILDING PE	RMIT
1	ISSUED FOR REVIEW	2023.03.15

DESCRIPTION

REV


DATE

PROJECT:

NEW TWO - FAMILY DWELLING

PROPOSED SITE PLAN

DRAWN BY:	VMZ
CHECKED BY:	MS
DATE:	2023.03.21
CLIENT:	DWG:
	A 4 O 4
SCALE:	A101
1 : 100	

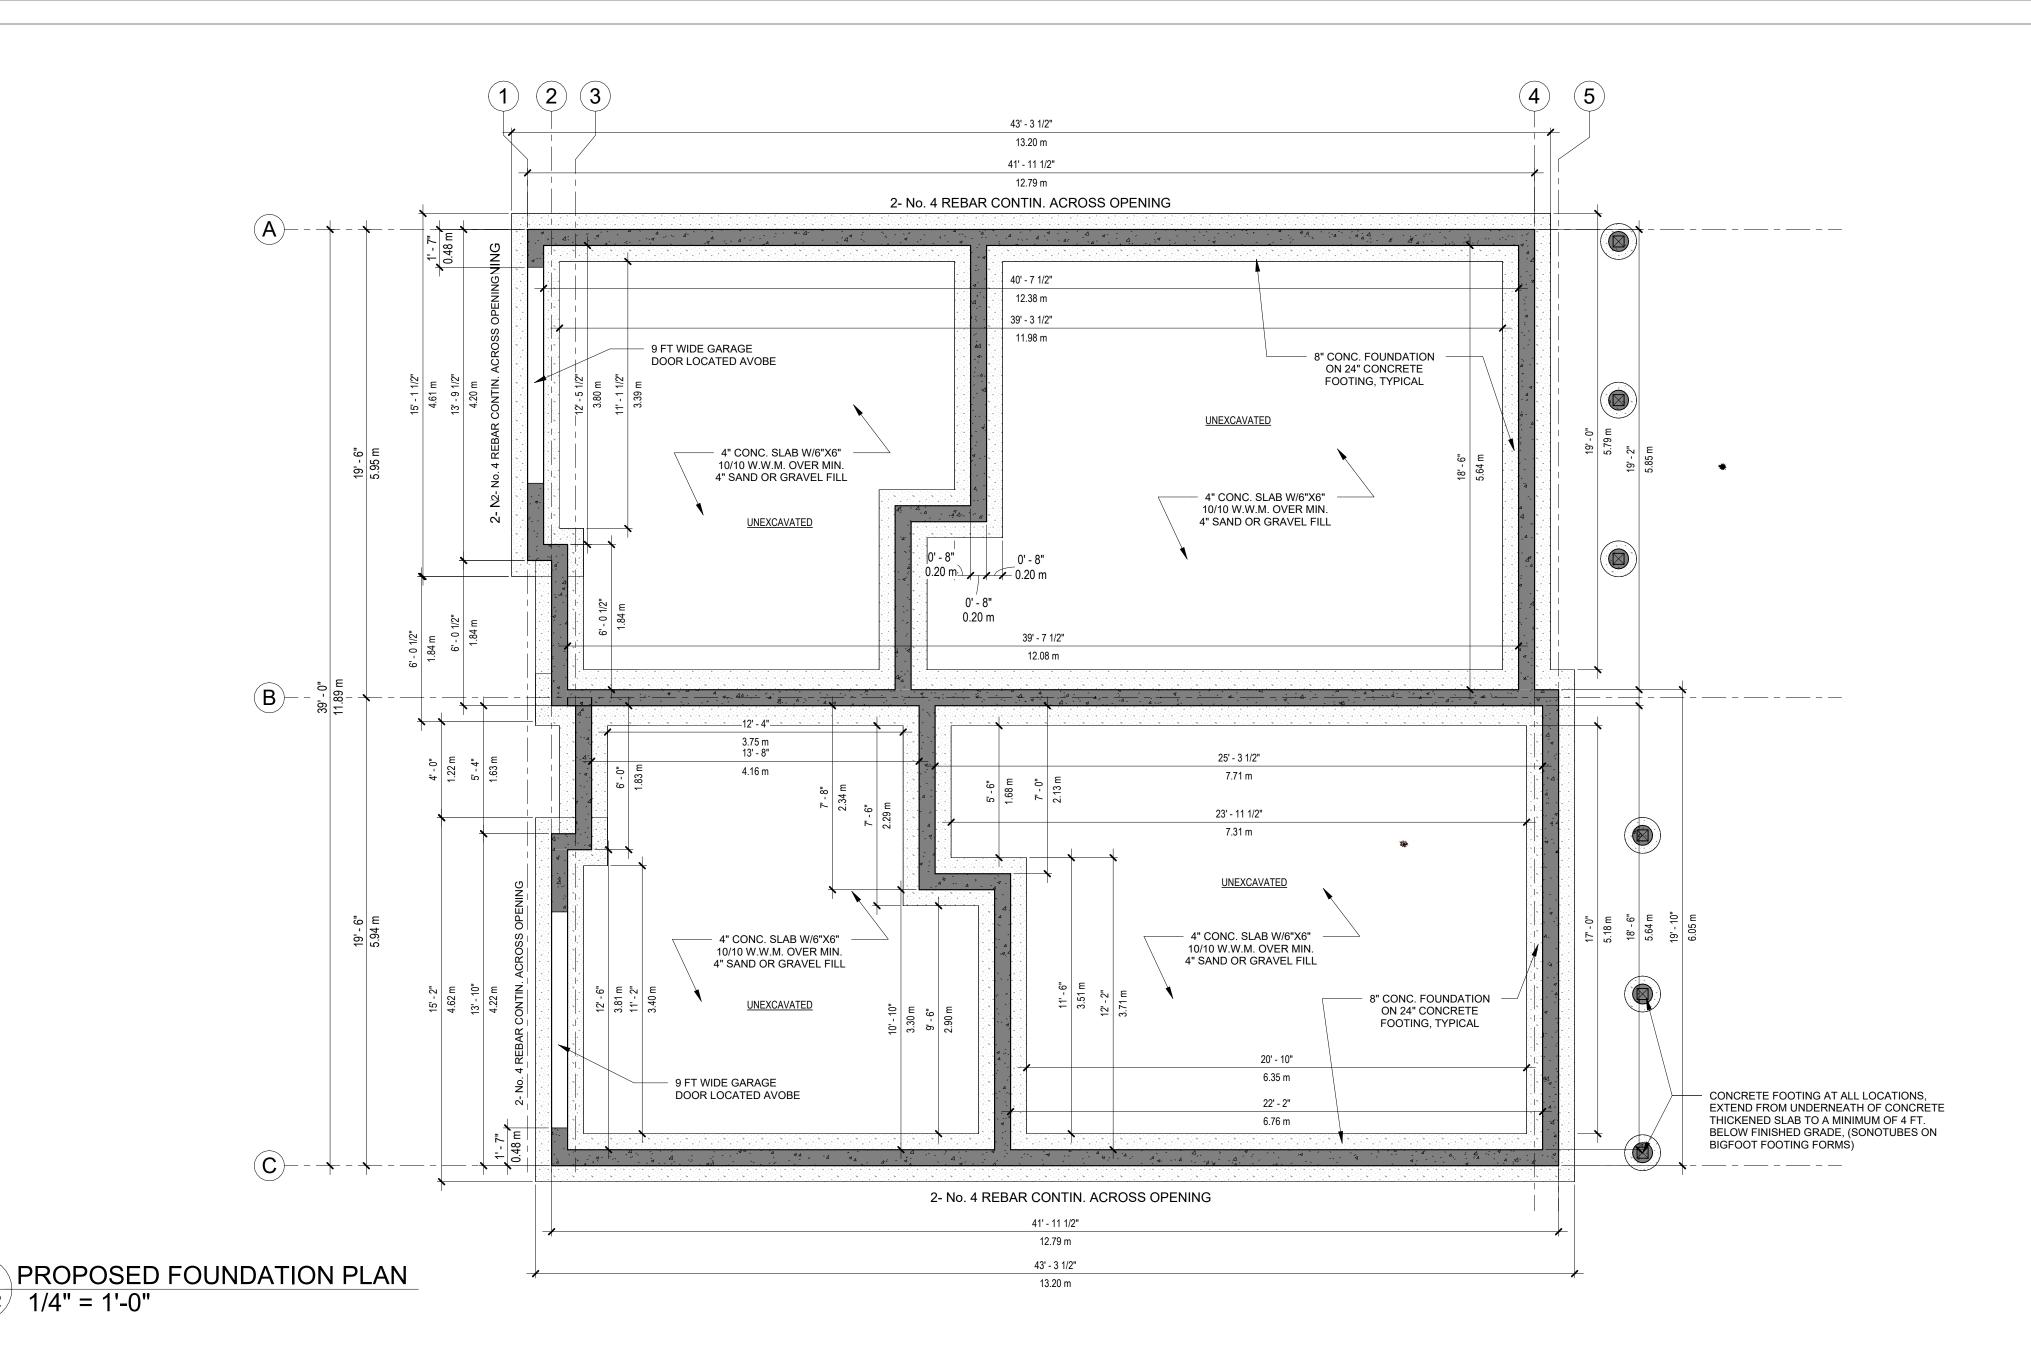



A102 1/4" = 1'-0"

- 1. FOOTINGS ARE TO BEAR ON UNDISTURBED LEVEL SOIL DEVOID OF ANY ORGANIC MATERIAL & STEPPED AS REQUIRED TO MAINTAIN THE REQUIRED DEPTH BELOW THE FINAL GRADE.
- 2. SOIL BEARING PRESSURE ASSUMED TO BE 1500 PSF.
- 3. ANY FILL UNDER GRADE SUPPORTED SLABS TO BE MINIMUM OF 4" GRANULAR MATERIAL COMPACTED TO 95%.
- 4. CONCRETE:

-BASEMENT WALLS & FOUNDATION NOT EXPOSED TO WEATHER: 2,500 PSI -BASEMENT & INTERIOR SLAB ON GRADE: 2,500 PSI -BASEMENT WALLS & FOUNDATION EXPOSED TO THE WEATHER: 2,500 PSI -PORCHES, STEPS & CARPORT SLABS EXPOSED TO WEATHER: 2,500 PSI

- 5. CONCRETE SLABS TO HAVE CONTROL JOINTS AT 25' (MAXIMUM) INTERVALS EA. WAY.
- 6. REINFORCING STEEL TO BE A-615 GRADE 60. WIRE MESH TO BE A-185.
- 7. ALL WOOD IN CONTACT WITH CONCRETE TO BE PRESSURE TREATED OR PROTECTED WITH 55# ROLL ROOFING.

NOTE

BUILDER MUST CHECK AND VERIFY GRADES AND DIMENSIONS, BEFORE CONSTRUCTION COMMENCES

4" SOIL GAS PIPE REQUIRED THRU FLOOR SLAB. OWNER AND/OR BULDER TO CHOOSE LOCATION

WT1 FROST WALL

- 2" SM TYPE RIGID INSULATION(R10)
- C/W PROTECTION BOARD
- DAMP PROOFING
- 8" REINFORCED CONCRETE WALL



360 CAD SERVICES INC.

"Where Imagination & Reality Collide"

GENERAL NOTES:

NOT FOR CONSTRUCTION

ALL DIMENSIONS TO BE VERIFIED ON SITE AND CONFIRMED BY CONTRACTOR.

DO NOT SCALE THIS DRAWING.

REV	DESCRIPTION	DATE
1	ISSUED FOR REVIEW	2023.03.1

ISSUED FOR BUILDING PERMIT


DRAWING TITLE:

PROPOSED FOUNDATION PLAN

PROJECT:

NEW TWO - FAMILY DWELLING

DRAWN BY:	VMZ
CHECKED BY:	MS
DATE:	2023.03.21
CLIENT:	DWG:
	4400
SCALE:	A102
1/4" = 1'-0"	

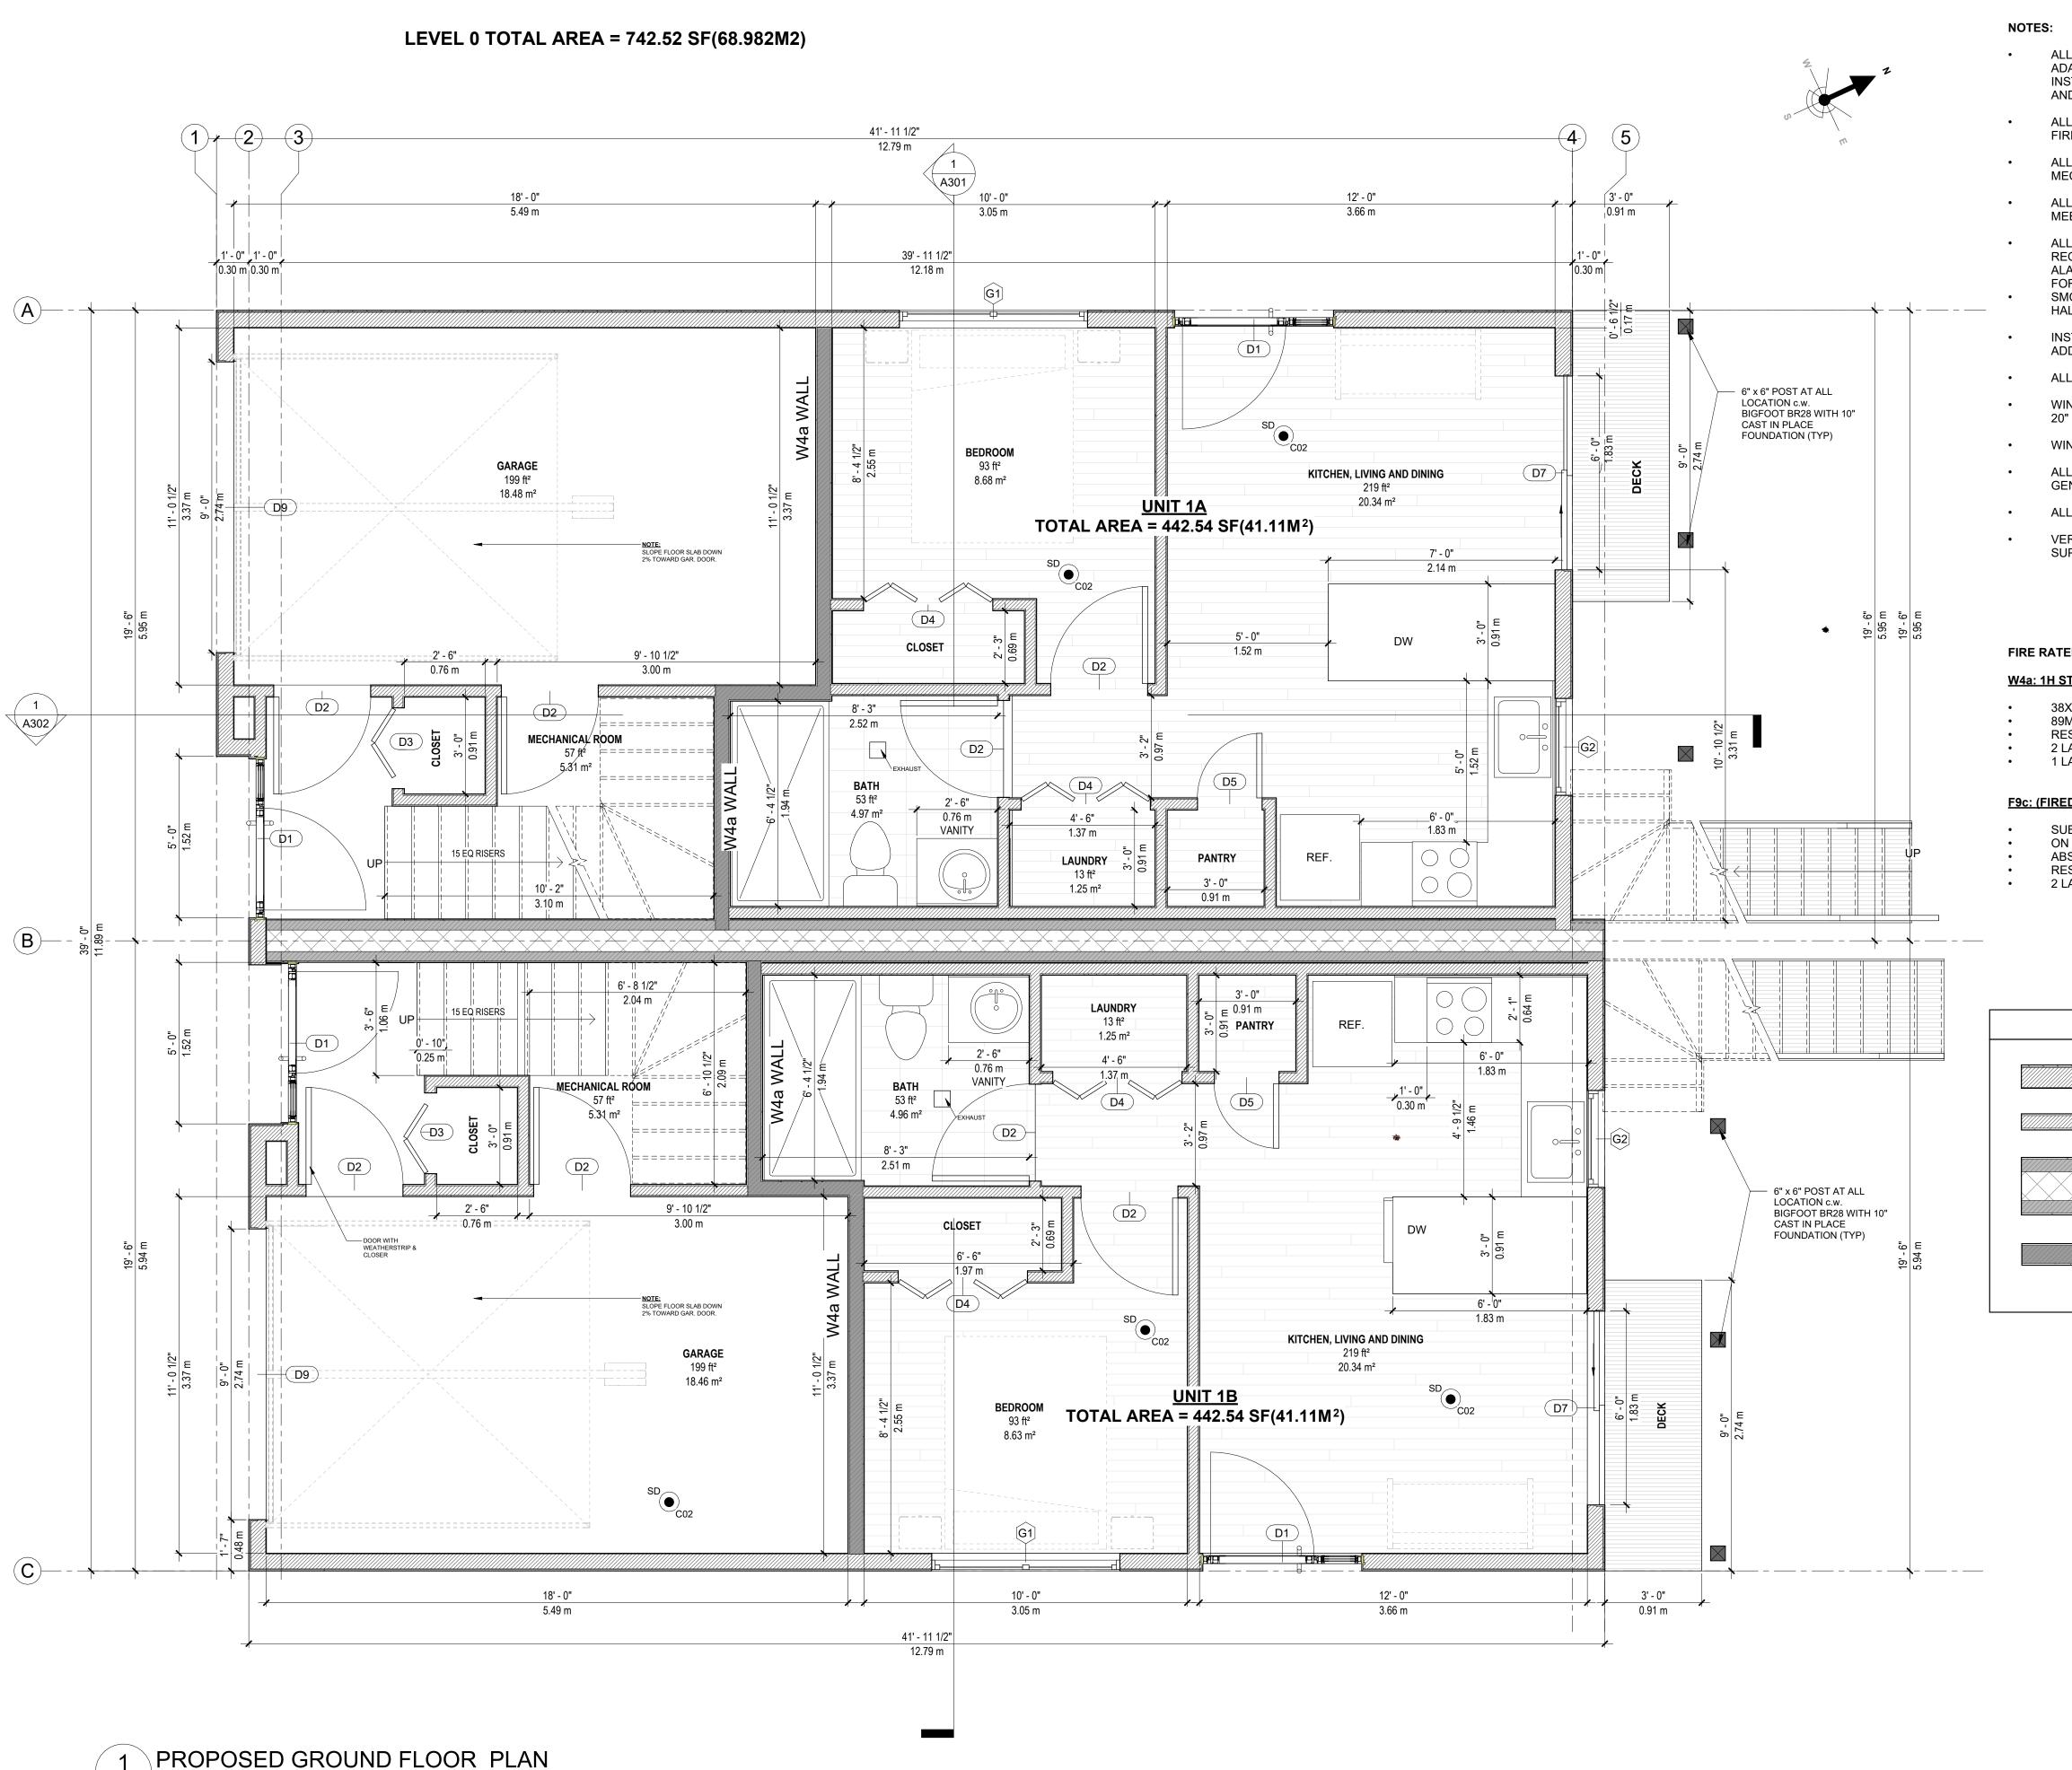

A103 3/8" = 1'-0"

- ALL SECONDARY UNITS TO MEET 3.8.4 OF THE NSBCR FOR ADAPTABLE HOUSING. 3-FOOT WIDE DOORS AND PLUMBING INSTALLED DO IT CAN BE ADAPTED TO 34-INCH HIGH COUNTERS AND VANITIES.
- ALL UNITS TO HAVE AN HRV SYSTEM AND TO BE DUCTED BELOW FIRE SEPARATION
- ALL HEATING SOURCES ARE ELECTRIC WITH HWT 40 AND 60 GAL. MECHANICAL ROOM IN GROUND FLOOR.
- ALL PENETRATES BY FIXTURES, DUCTWORK, OR ELEMENTS WILL MEET 9.10.9.6.
- ALL SMOKE DETECTOR SYSTEMS FOR INDIVIDUAL UNITS REQUIRED HARD WIRED, INTERCONNECTED TO SOUND WHEN ONE ALARM SOUNDS WITH BATTERY BACKUP, BUT ARE INDEPENDENT FOR EACH INDIVIDUAL SUITE.
- SMOKE/CO COMBO ALARMS ARE REQUIRED ON EACH LEVEL IN HALLWAYS, SERVINGS ROOMS AS WELL
- INSTALL HEAT PUMPS TO PROVIDE ELECTRIC HEAT TO NEW ADDITION
- ALL WINDOWS WILL BE EGRESS WINDOWS
- WINDOWS MUST HAVE A CLEAR AND UNOBSTRUCTED OPENING OF 20" WIDE BY 24" HIGH (minimum)
- WINDOW STYLE AND FINISH TO BE DETERMINED BY CLIENT
- ALL SITE DIMENSIONS AND SILL HEIGHTS TO BE VERIFIED BY GENERAL CONTRACTOR
- ALL WINDOW DIMENSIONS ARE ROUGH STUD OPENING
- VERIFY RSO MEASURMENT WITH WINDOWS AND DOORS
 SUPPLIER

FIRE RATED SCHEDULE:

W4a: 1H STC 51 (FIRE RATED WALL). SHADED IN DARK GREY

- 38X89MM STUDS SPACED 400MM OC
- 89MM THICK ABSORPTIVE MATERIAL
- RESILIENT METAL CHANNEL ON SIDE SPACED 400MM O.C.
 2 LAYERS 15.9MM TYPE X GWB
- 1 LAYER 12.7MM GWB ON OTHER SIDE

F9c: (FIRED RATED CEILING)

- SUBFLOOR OF 17MM TONGUE & GROOVE LUMBER
- ON WOOD JOISTS@400MM O.C. ABSORPTIVE MATERIAL IN CAVITY
- ABSORPTIVE MATERIAL IN CAVITY
 RESILIENT METAL CHANNEL SPACED 400MM O.C.
 - 2 LAYERS 15.9MM TYPE X GWB

WALL SCHEDULE

EXTERIOR WALLS

FIRE RATED WALLS

INTERIOR WALLS

(CENTRE WALL)

FIRE RATED WALLS (W4a)



360 CAD SERVICES INC.
"Where Imagination & Reality Collide"

GENERAL NOTES:

NOT FOR CONSTRUCTION

ALL DIMENSIONS TO BE VERIFIED ON SITE AND CONFIRMED BY CONTRACTOR.

DO NOT SCALE THIS DRAWING.

REV	DESCRIPTION	DATE
1	ISSUED FOR REVIEW	2023.03.15

ISSUED FOR BUILDING PERMIT


DRAWING TITLE:

PROPOSED FLOOR PLAN -LEVEL 0

PROJECT:

NEW TWO - FAMILY DWELLING

DRAWN BY:	VMZ
CHECKED BY:	MS
DATE:	2023.03.21
CLIENT:	DWG:
	A 400
SCALE:	A103
As indicated	

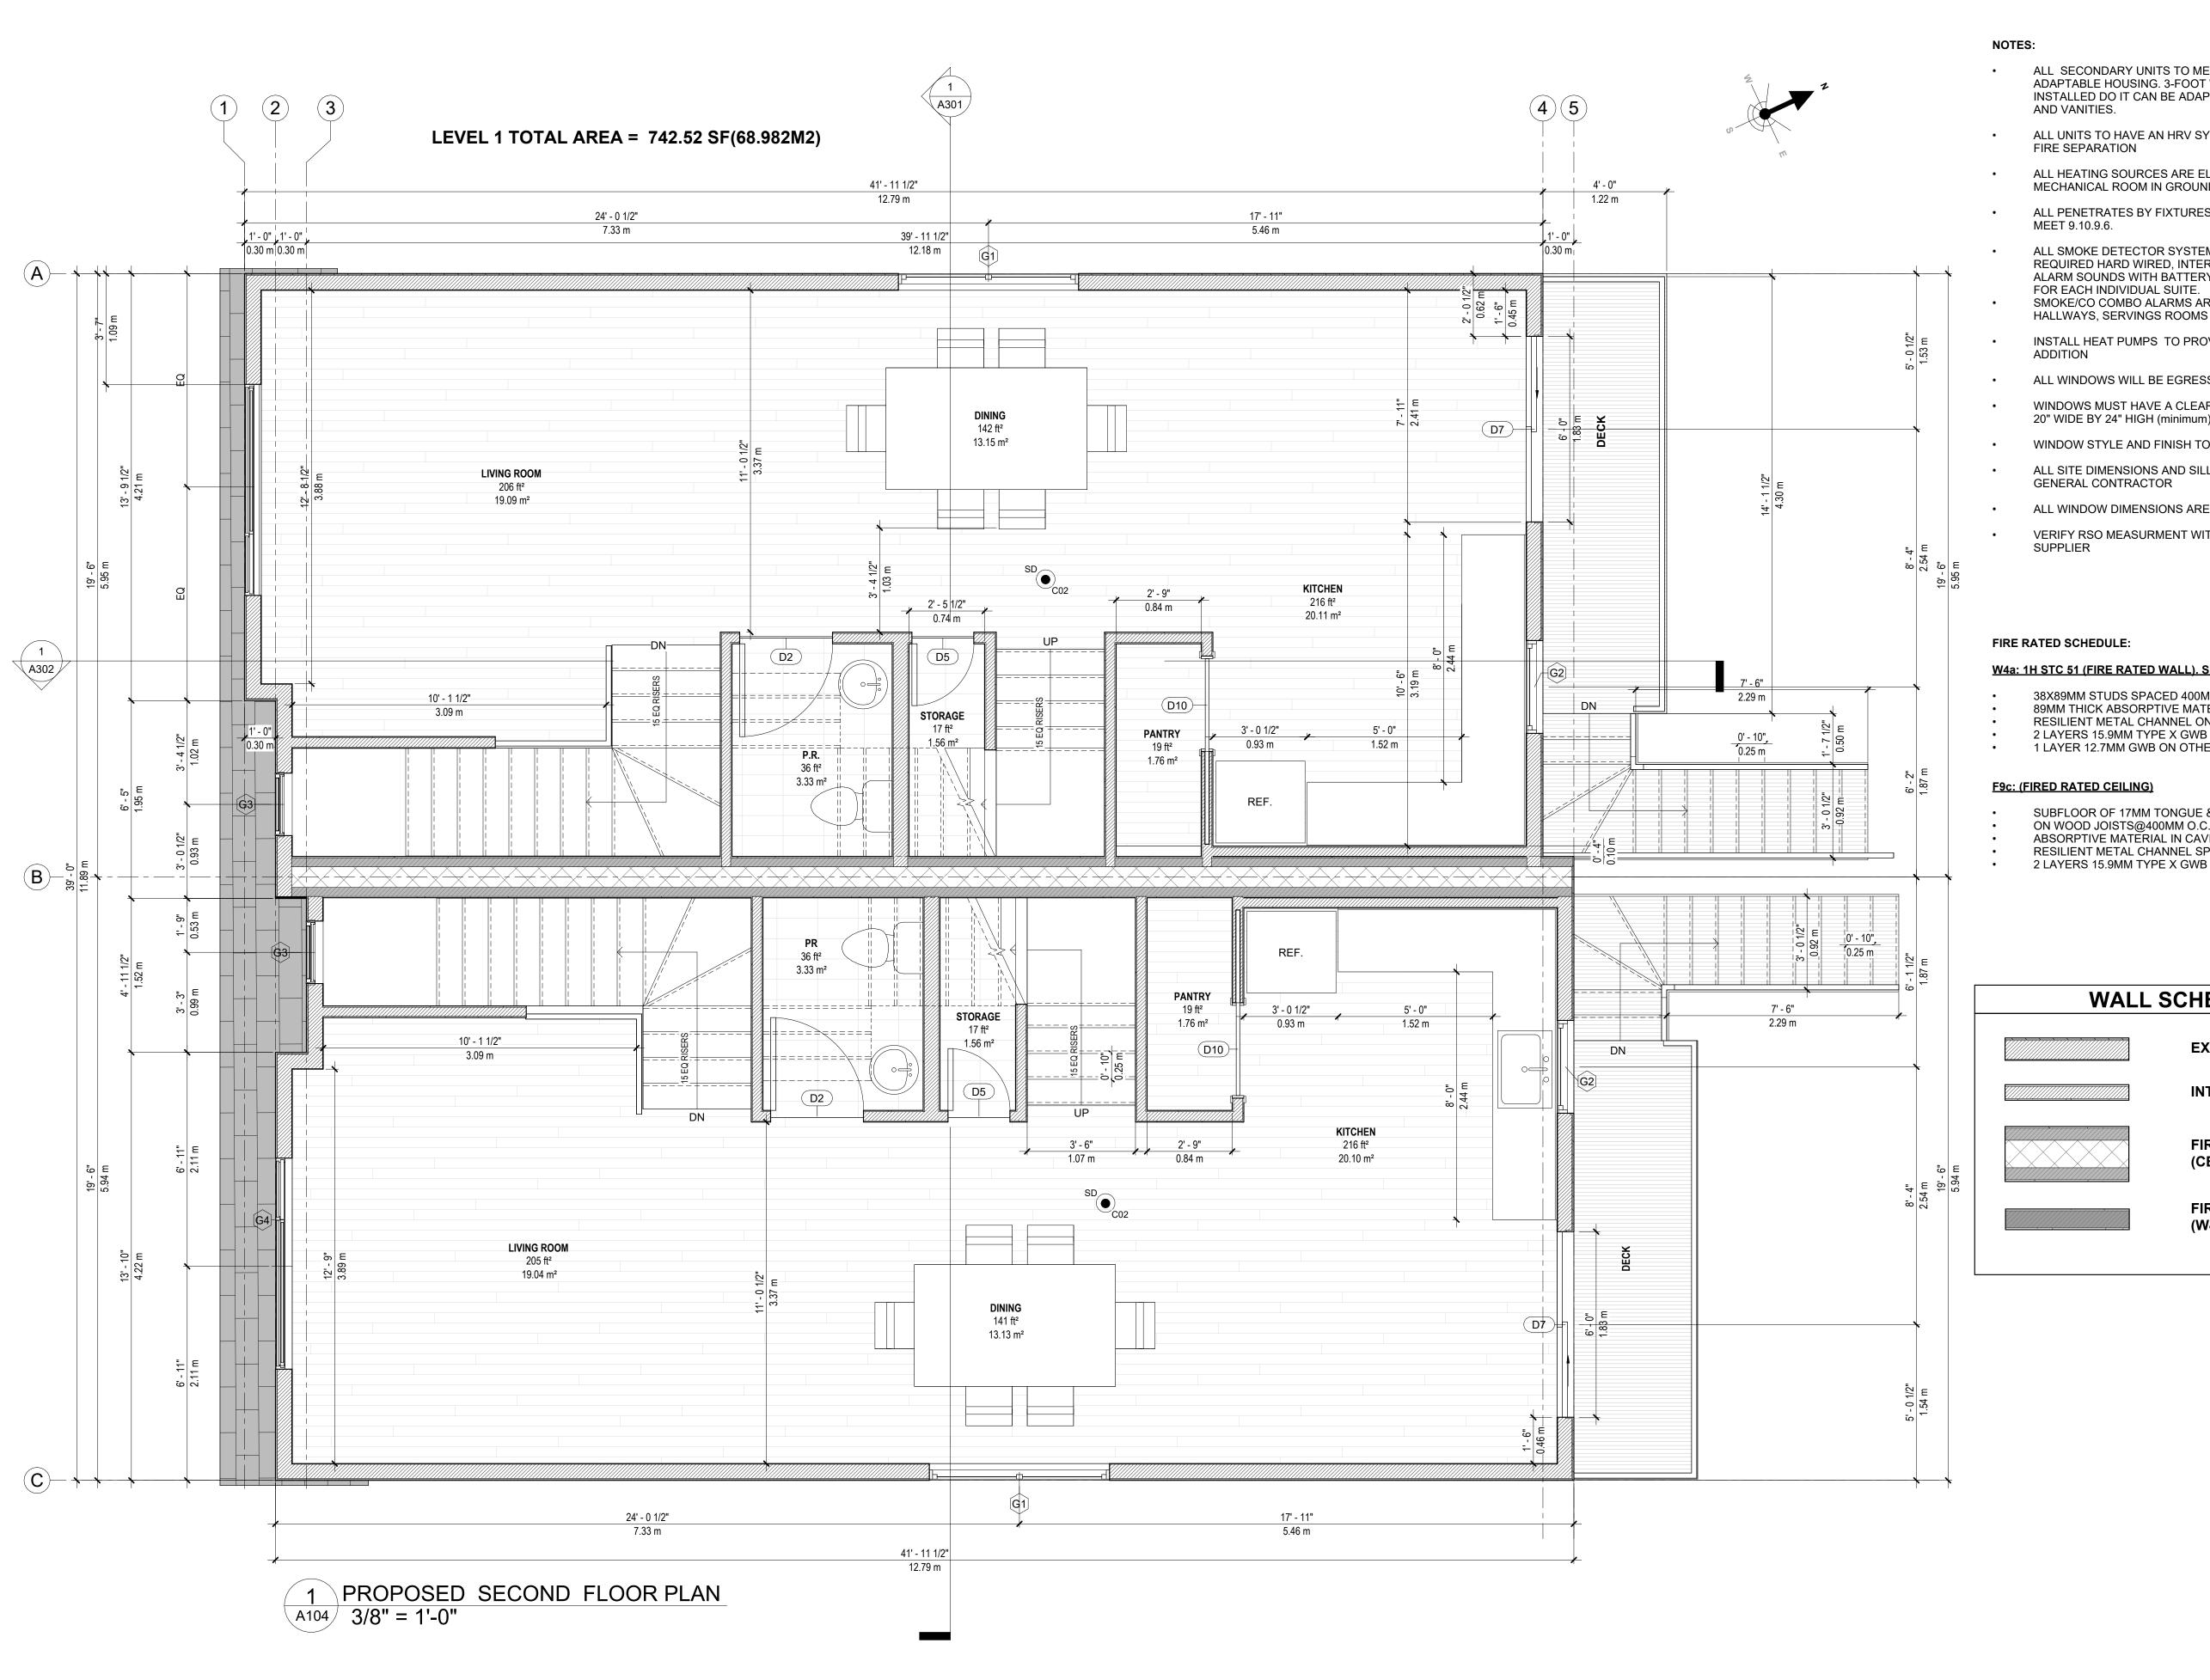

- ALL SECONDARY UNITS TO MEET 3.8.4 OF THE NSBCR FOR ADAPTABLE HOUSING. 3-FOOT WIDE DOORS AND PLUMBING INSTALLED DO IT CAN BE ADAPTED TO 34-INCH HIGH COUNTERS
- ALL UNITS TO HAVE AN HRV SYSTEM AND TO BE DUCTED BELOW FIRE SEPARATION
- ALL HEATING SOURCES ARE ELECTRIC WITH HWT 40 AND 60 GAL. MECHANICAL ROOM IN GROUND FLOOR.
- ALL PENETRATES BY FIXTURES, DUCTWORK, OR ELEMENTS WILL
- ALL SMOKE DETECTOR SYSTEMS FOR INDIVIDUAL UNITS REQUIRED HARD WIRED, INTERCONNECTED TO SOUND WHEN ONE ALARM SOUNDS WITH BATTERY BACKUP, BUT ARE INDEPENDENT FOR EACH INDIVIDUAL SUITE.
- SMOKE/CO COMBO ALARMS ARE REQUIRED ON EACH LEVEL IN HALLWAYS, SERVINGS ROOMS AS WELL
- INSTALL HEAT PUMPS TO PROVIDE ELECTRIC HEAT TO NEW
- ALL WINDOWS WILL BE EGRESS WINDOWS
- WINDOWS MUST HAVE A CLEAR AND UNOBSTRUCTED OPENING OF 20" WIDE BY 24" HIGH (minimum)
- WINDOW STYLE AND FINISH TO BE DETERMINED BY CLIENT
- ALL SITE DIMENSIONS AND SILL HEIGHTS TO BE VERIFIED BY GENERAL CONTRACTOR
- ALL WINDOW DIMENSIONS ARE ROUGH STUD OPENING
- VERIFY RSO MEASURMENT WITH WINDOWS AND DOORS SUPPLIER

FIRE RATED SCHEDULE:


W4a: 1H STC 51 (FIRE RATED WALL). SHADED IN DARK GREY

- 38X89MM STUDS SPACED 400MM OC
- 89MM THICK ABSORPTIVE MATERIAL
- RESILIENT METAL CHANNEL ON SIDE SPACED 400MM O.C.
- 1 LAYER 12.7MM GWB ON OTHER SIDE


F9c: (FIRED RATED CEILING)

- SUBFLOOR OF 17MM TONGUE & GROOVE LUMBER
- ON WOOD JOISTS@400MM O.C. ABSORPTIVE MATERIAL IN CAVITY
- RESILIENT METAL CHANNEL SPACED 400MM O.C.
- 2 LAYERS 15.9MM TYPE X GWB


WALL SCHEDULE

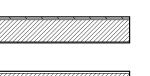

EXTERIOR WALLS

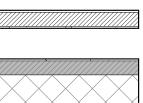


INTERIOR WALLS

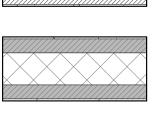

FIRE RATED WALLS (CENTRE WALL)

FIRE RATED WALLS (W4a)

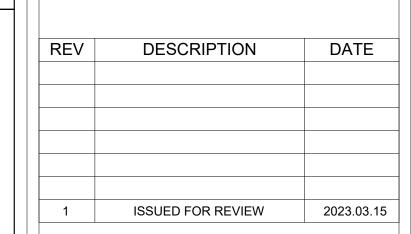

360 CAD SERVICES INC.

"Where Imagination & Reality Collide"

GENERAL NOTES:

NOT FOR CONSTRUCTION

CONTRACTOR.

ALL DIMENSIONS TO BE VERIFIED ON SITE AND CONFIRMED BY

DO NOT SCALE THIS DRAWING.

ISSUED FOR BUILDING PERMIT


DRAWING TITLE:

PROPOSED FLOOR PLAN -LEVEL 1

PROJECT:

NEW TWO - FAMILY DWELLING

DRAWN BY:	VMZ
CHECKED BY:	MS
DATE:	2023.03.2
CLIENT:	DWG:
	A 4 0 4
SCALE:	A104
As indicated	

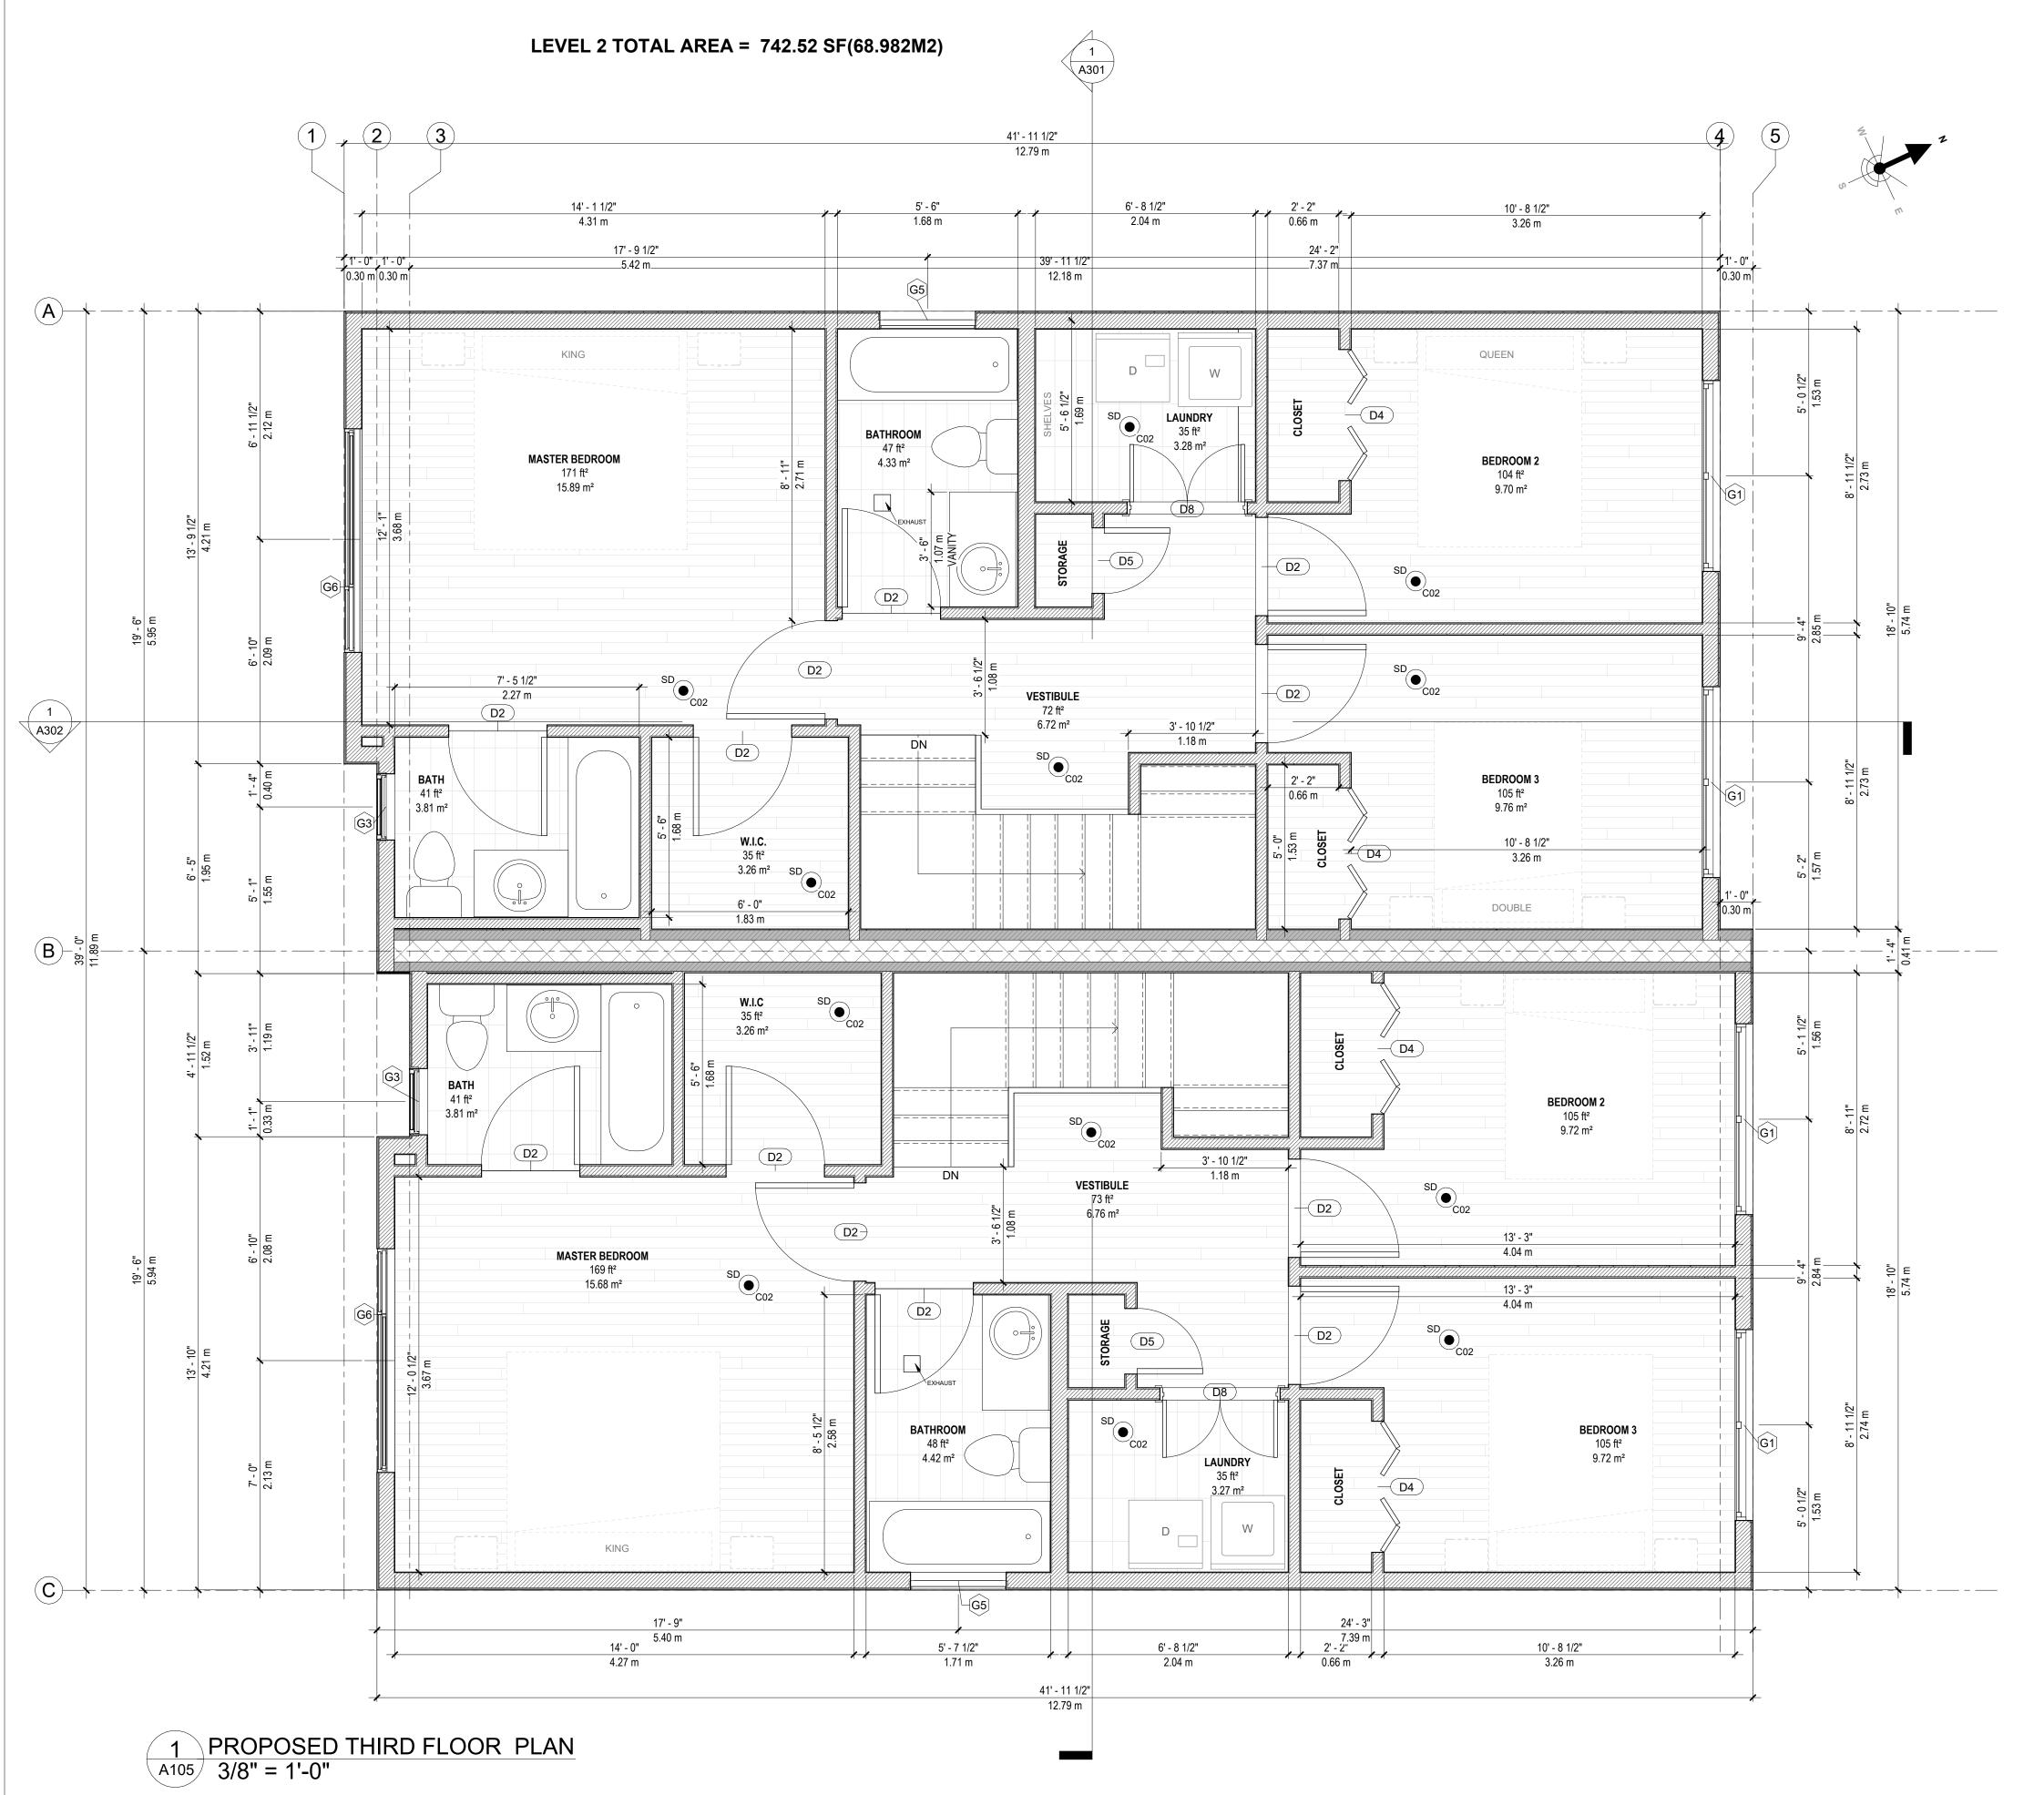

NOTES:

- ALL SECONDARY UNITS TO MEET 3.8.4 OF THE NSBCR FOR ADAPTABLE HOUSING. 3-FOOT WIDE DOORS AND PLUMBING INSTALLED DO IT CAN BE ADAPTED TO 34-INCH HIGH COUNTERS AND VANITIES.
- ALL UNITS TO HAVE AN HRV SYSTEM AND TO BE DUCTED BELOW FIRE SEPARATION
- ALL HEATING SOURCES ARE ELECTRIC WITH HWT 40 AND 60 GAL.
 MECHANICAL ROOM IN GROUND FLOOR.
- ALL PENETRATES BY FIXTURES, DUCTWORK, OR ELEMENTS WILL MEET 9.10.9.6.
- ALL SMOKE DETECTOR SYSTEMS FOR INDIVIDUAL UNITS REQUIRED HARD WIRED, INTERCONNECTED TO SOUND WHEN ONE ALARM SOUNDS WITH BATTERY BACKUP, BUT ARE INDEPENDENT FOR EACH INDIVIDUAL SUITE.
- SMOKE/CO COMBO ALARMS ARE REQUIRED ON EACH LEVEL IN HALLWAYS, SERVINGS ROOMS AS WELL
- INSTALL HEAT PUMPS TO PROVIDE ELECTRIC HEAT TO NEW ADDITION
- ALL WINDOWS WILL BE EGRESS WINDOWS
- WINDOWS MUST HAVE A CLEAR AND UNOBSTRUCTED OPENING OF 20" WIDE BY 24" HIGH (minimum)
- WINDOW STYLE AND FINISH TO BE DETERMINED BY CLIENT
- ALL SITE DIMENSIONS AND SILL HEIGHTS TO BE VERIFIED BY GENERAL CONTRACTOR
- ALL WINDOW DIMENSIONS ARE ROUGH STUD OPENING
- VERIFY RSO MEASURMENT WITH WINDOWS AND DOORS
 SUPPLIED.

FIRE RATED SCHEDULE:

W4a: 1H STC 51 (FIRE RATED WALL). SHADED IN DARK GREY

- 38X89MM STUDS SPACED 400MM OC
- 89MM THICK ABSORPTIVE MATERIAL
- RESILIENT METAL CHANNEL ON SIDE SPACED 400MM O.C.
- 2 LAYERS 15.9MM TYPE X GWB
- 1 LAYER 12.7MM GWB ON OTHER SIDE

F9c: (FIRED RATED CEILING)

- SUBFLOOR OF 17MM TONGUE & GROOVE LUMBER
 ON WOOD JOISTS@400MM O.C.
- ABSORPTIVE MATERIAL IN CAVITY

2 LAYERS 15.9MM TYPE X GWB

RESILIENT METAL CHANNEL SPACED 400MM O.C.

EXTERIOR WALLS INTERIOR WALLS FIRE RATED WALLS (CENTRE WALL) FIRE RATED WALLS (W4a)



360 CAD SERVICES INC.
"Where Imagination & Reality Collide"

GENERAL NOTES:

NOT FOR CONSTRUCTION

ALL DIMENSIONS TO BE VERIFIED ON SITE AND CONFIRMED BY CONTRACTOR.

DO NOT SCALE THIS DRAWING.

REV	DESCRIPTION	DATE
1	ISSUED FOR REVIEW	2023.03.15

ISSUED FOR BUILDING PERMIT


DRAWING TITLE:

PROPOSED FLOOR PLAN -LEVEL 2

PROJECT:

NEW TWO - FAMILY DWELLING

VMZ
MS
2023.03.2
DWG:
A 40 =
A105

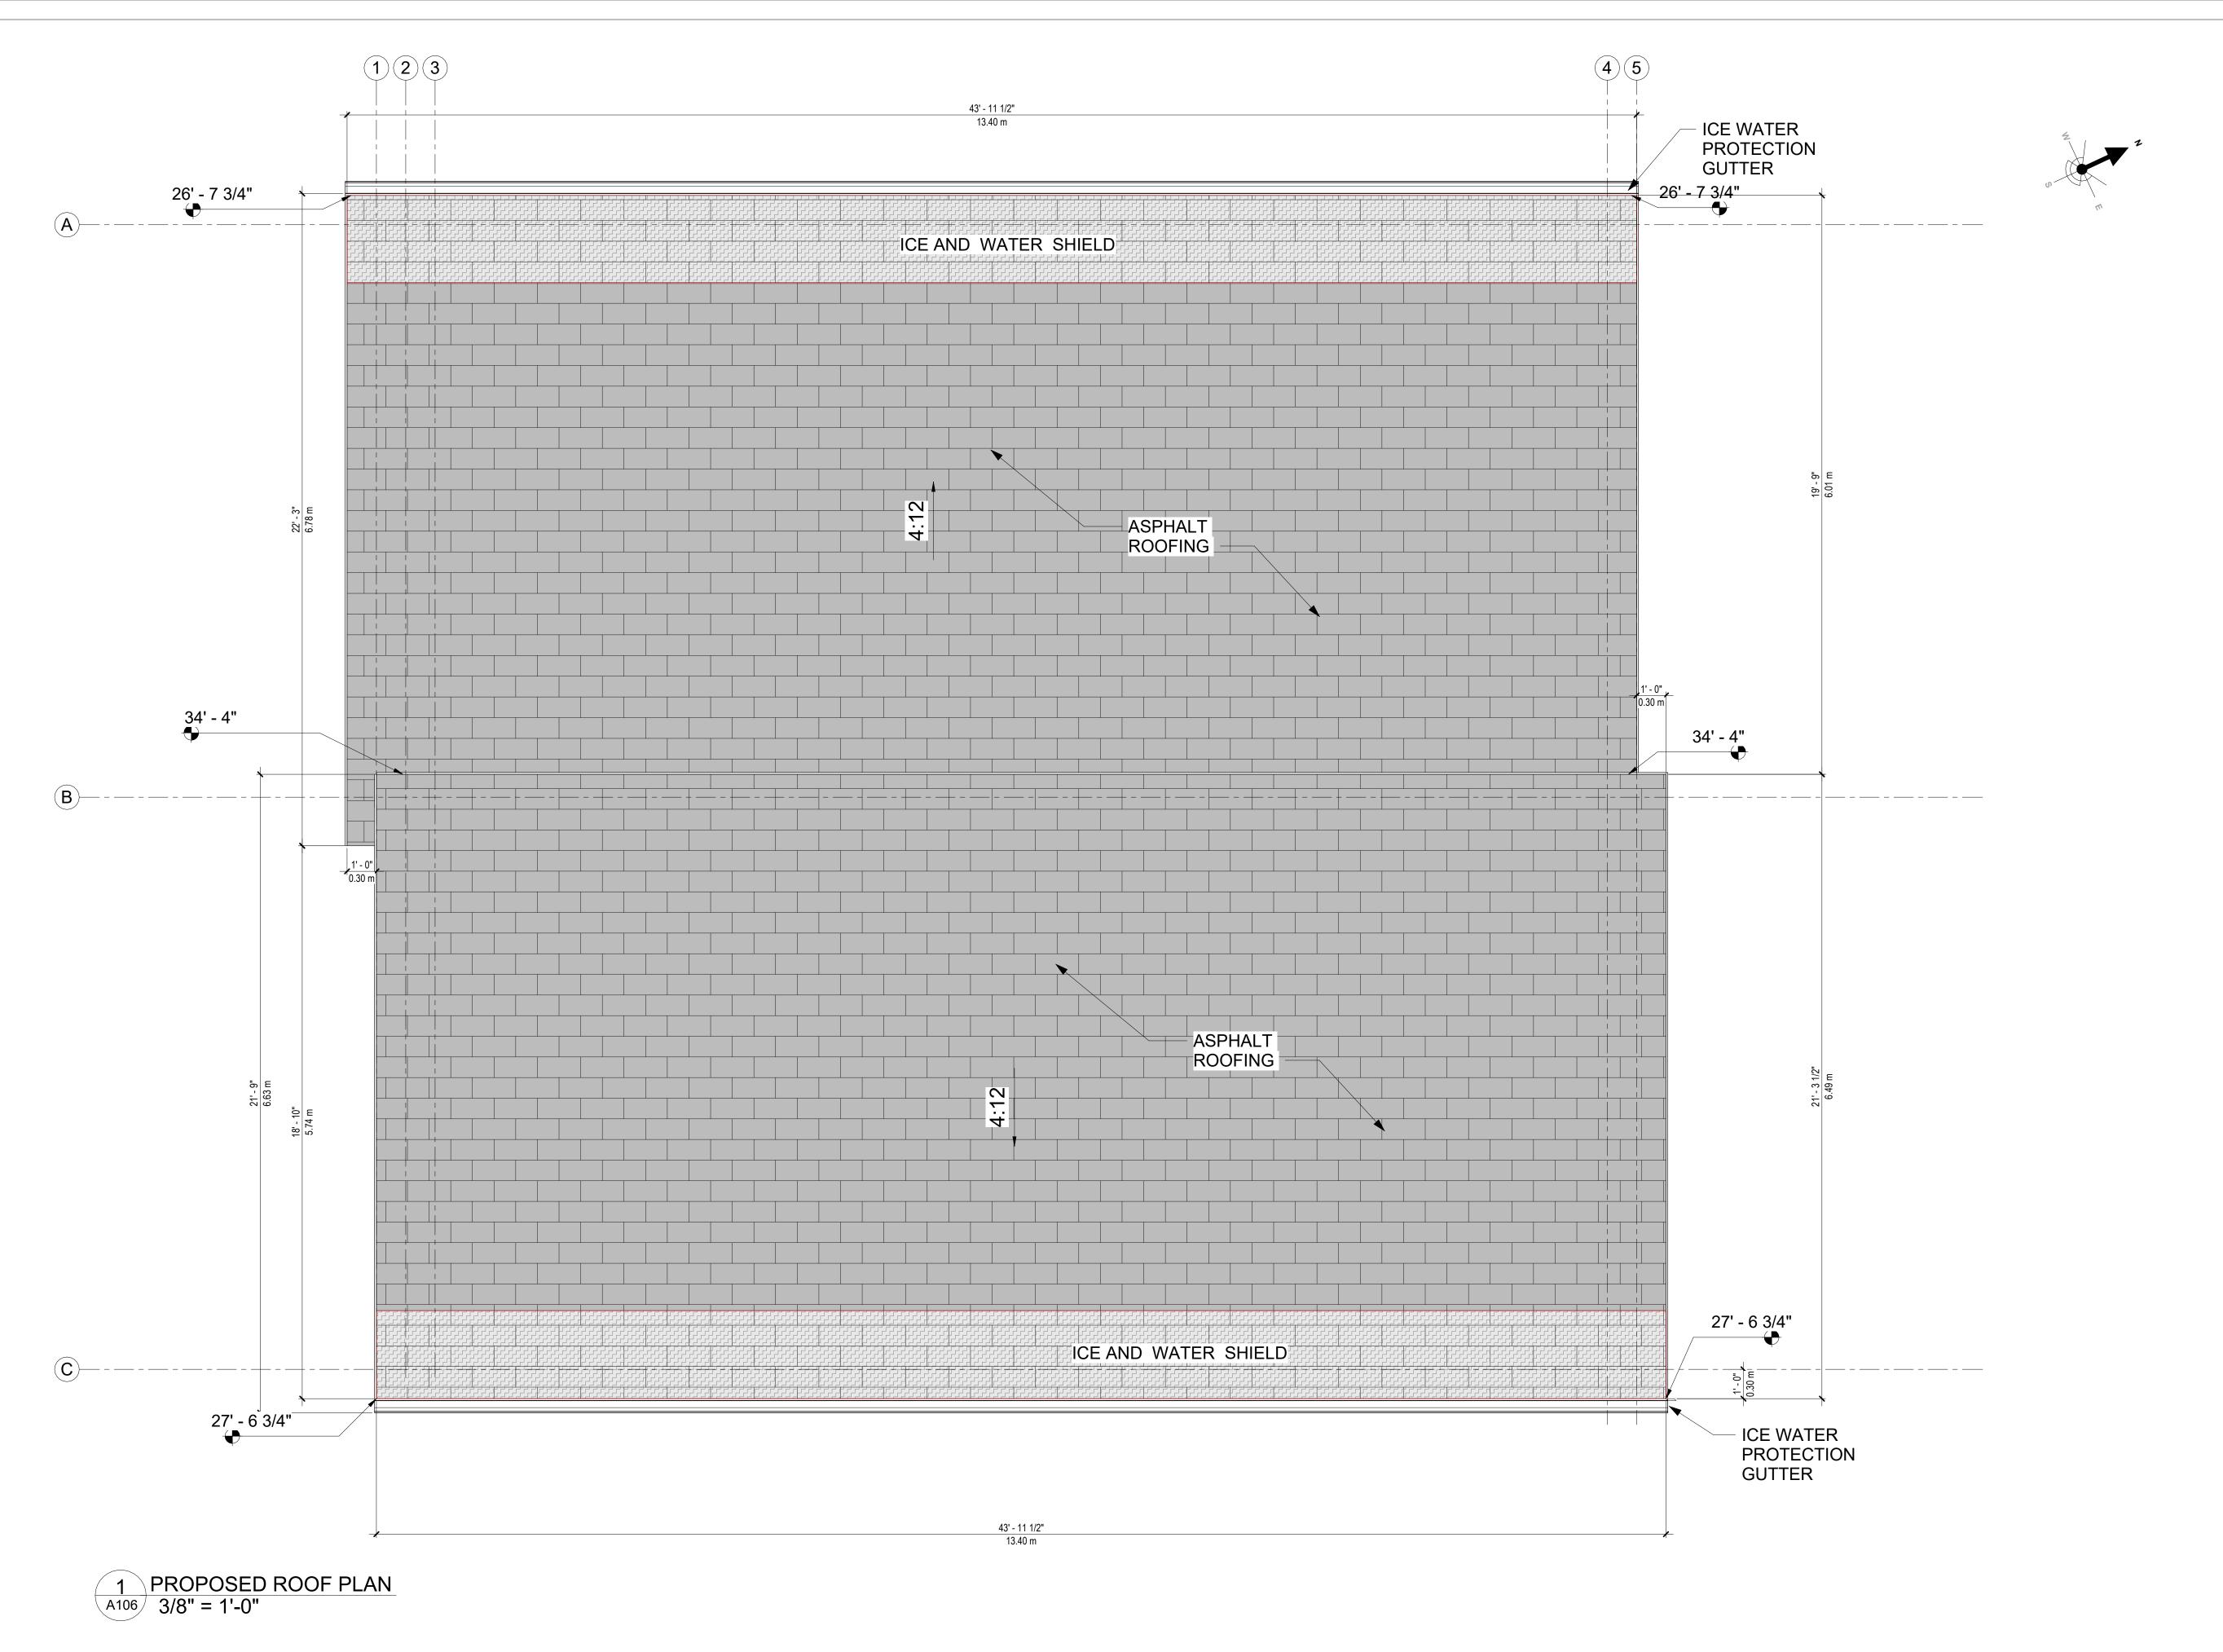



GENERAL NOTES:

NOT FOR CONSTRUCTION

ALL DIMENSIONS TO BE VERIFIED ON SITE AND CONFIRMED BY CONTRACTOR.

DO NOT SCALE THIS DRAWING.

REV	DESCRIPTION	DATE
1	ISSUED FOR REVIEW	2023.03.15

ISSUED FOR BUILDING PERMIT


DRAWING TITLE:

PROPOSED ROOF PLAN

PROJECT:

NEW TWO - FAMILY DWELLING

DRAWN BY:	VMZ
CHECKED BY:	MS
DATE:	2023.03.21
CLIENT:	DWG:
	4.400
SCALE:	A106
3/8" = 1'_0"	

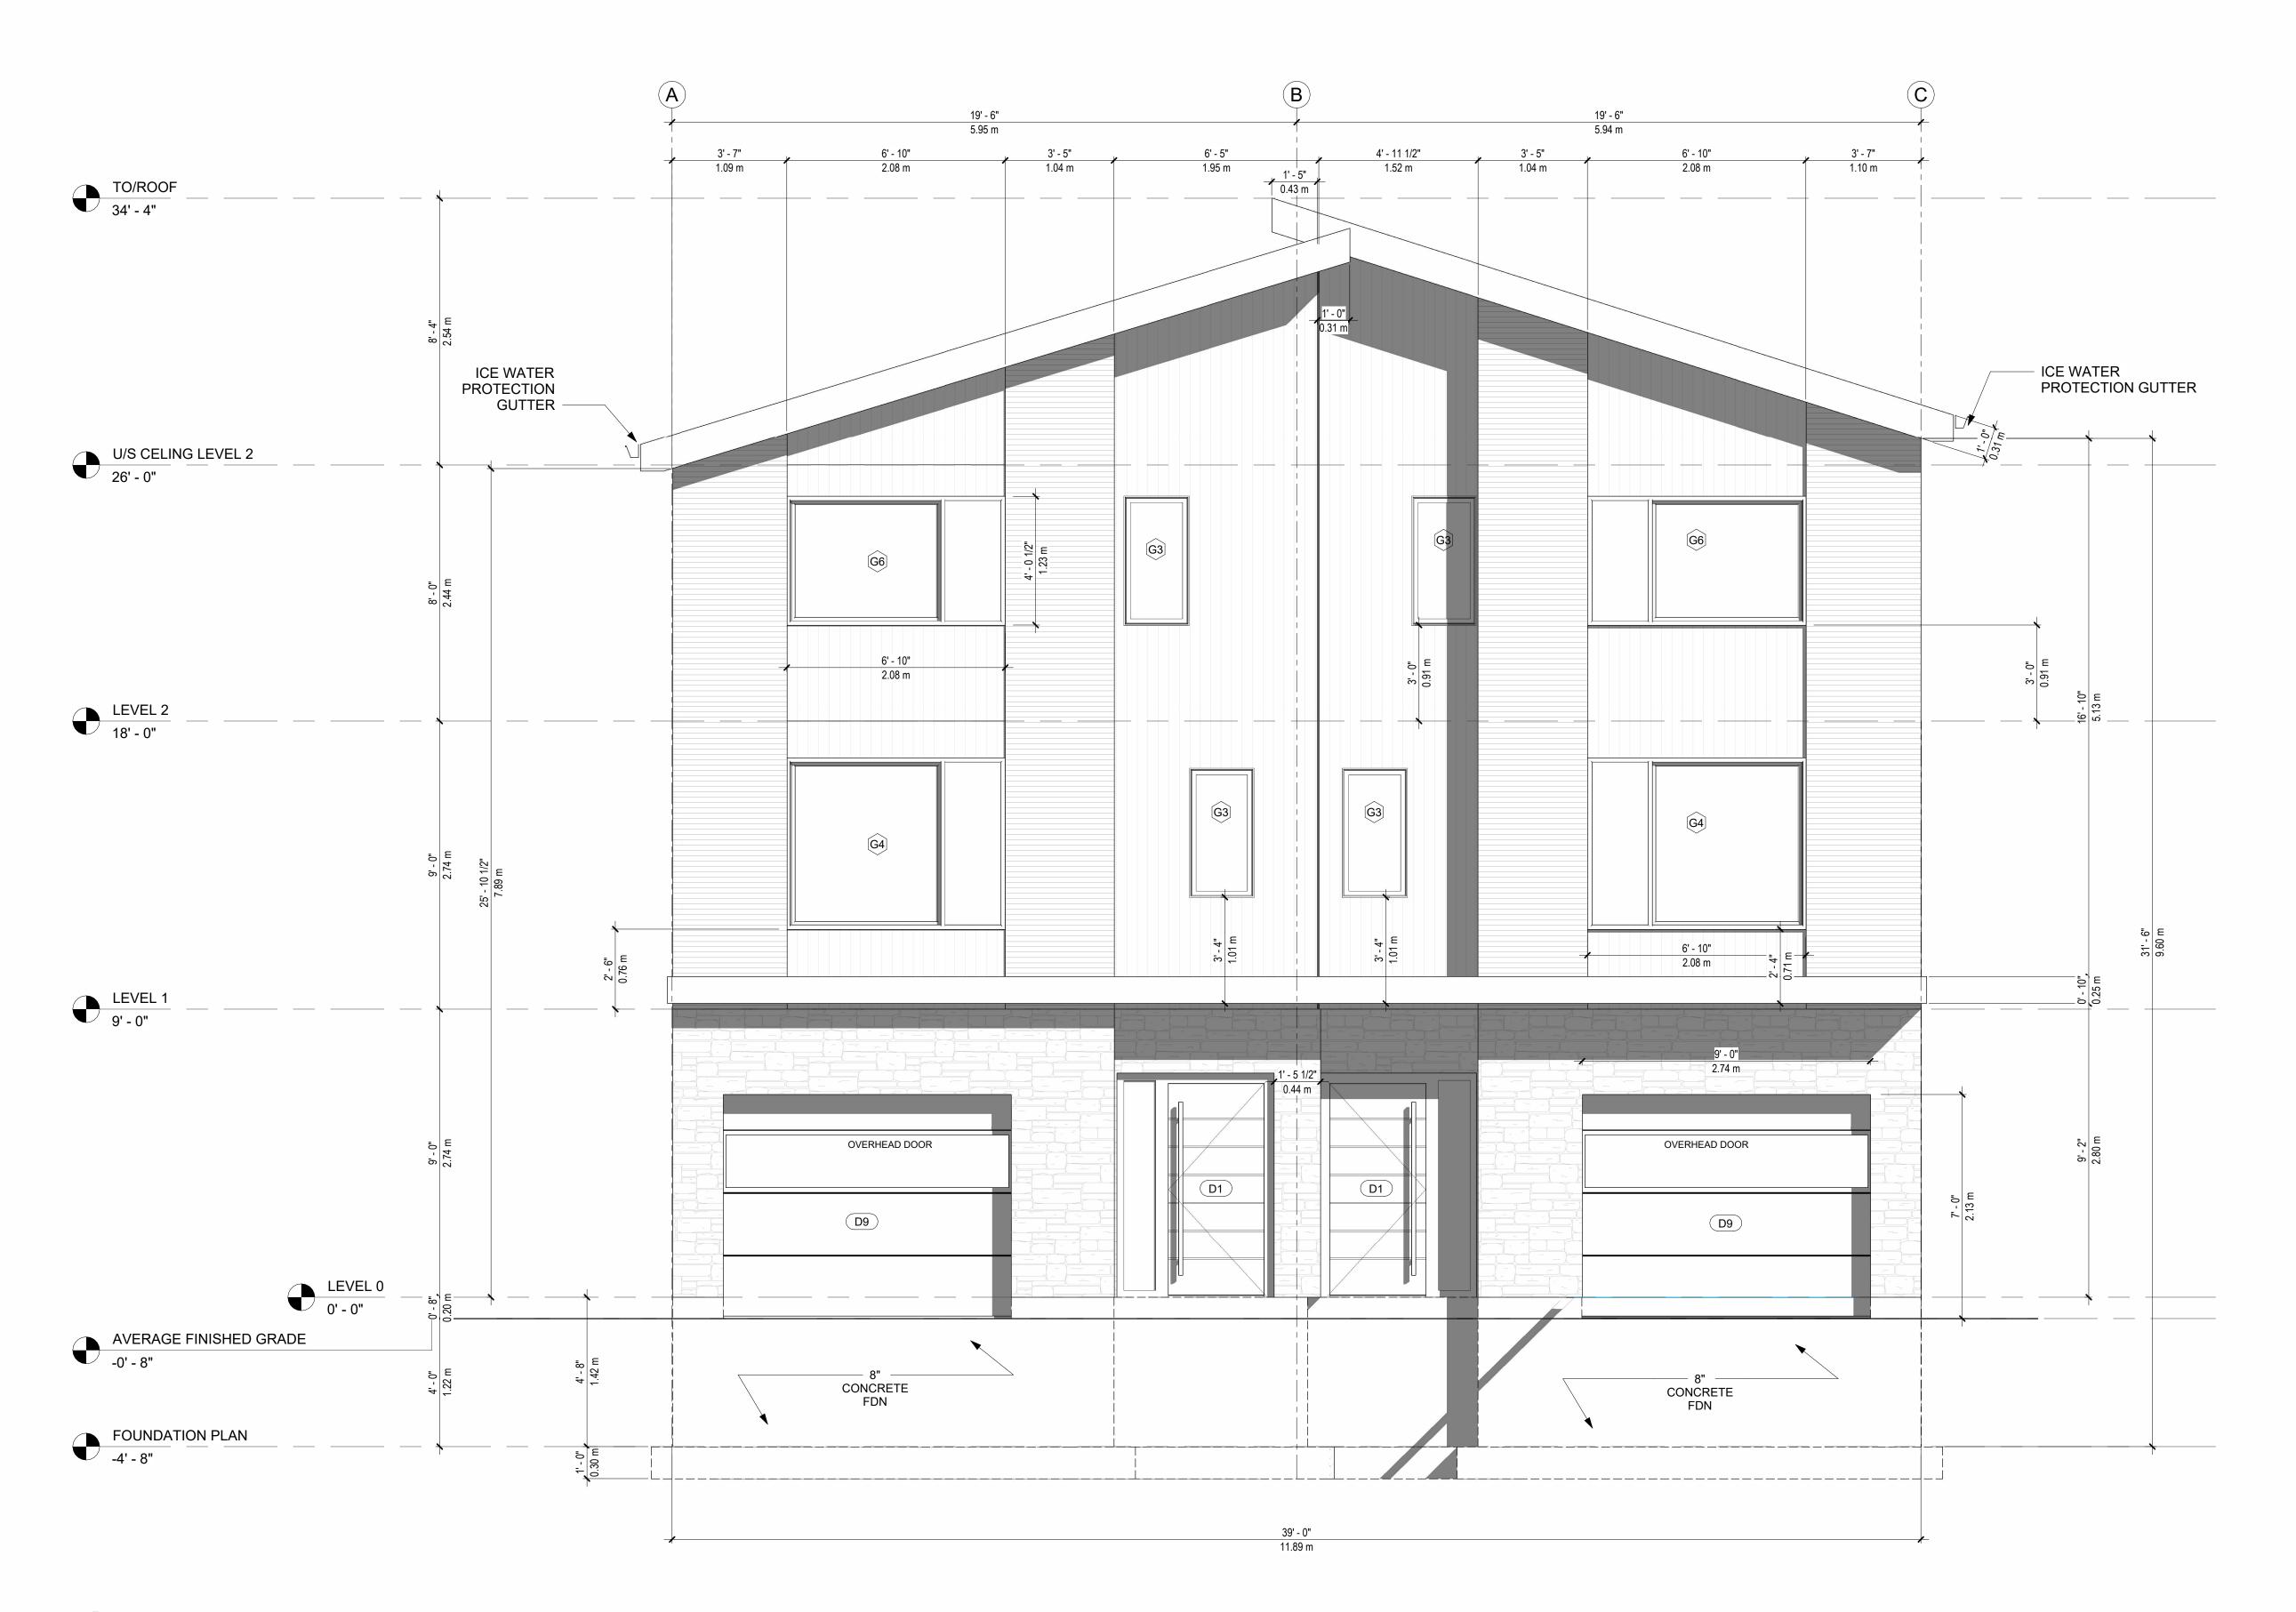

1 PROPOSED SOUTH ELEVATION A201 3/8" = 1'-0"



"Where Imagination & Reality Collide"

GENERAL NOTES:

NOT FOR CONSTRUCTION

ALL DIMENSIONS TO BE VERIFIED ON SITE AND CONFIRMED BY CONTRACTOR.

DO NOT SCALE THIS DRAWING.

	DESCRIPTION	DATE
1	ISSUED FOR REVIEW	2023.03.15

ISSUED FOR BUILDING PERMIT


DRAWING TITLE:

PROPOSED SOUTH ELEVATION

PROJECT:

NEW TWO - FAMILY DWELLING

DRAWN BY:	VMZ
CHECKED BY:	MS
DATE:	2023.03.21
CLIENT:	DWG:
	4 004
SCALE:	A201
3/8" = 1'-0"	

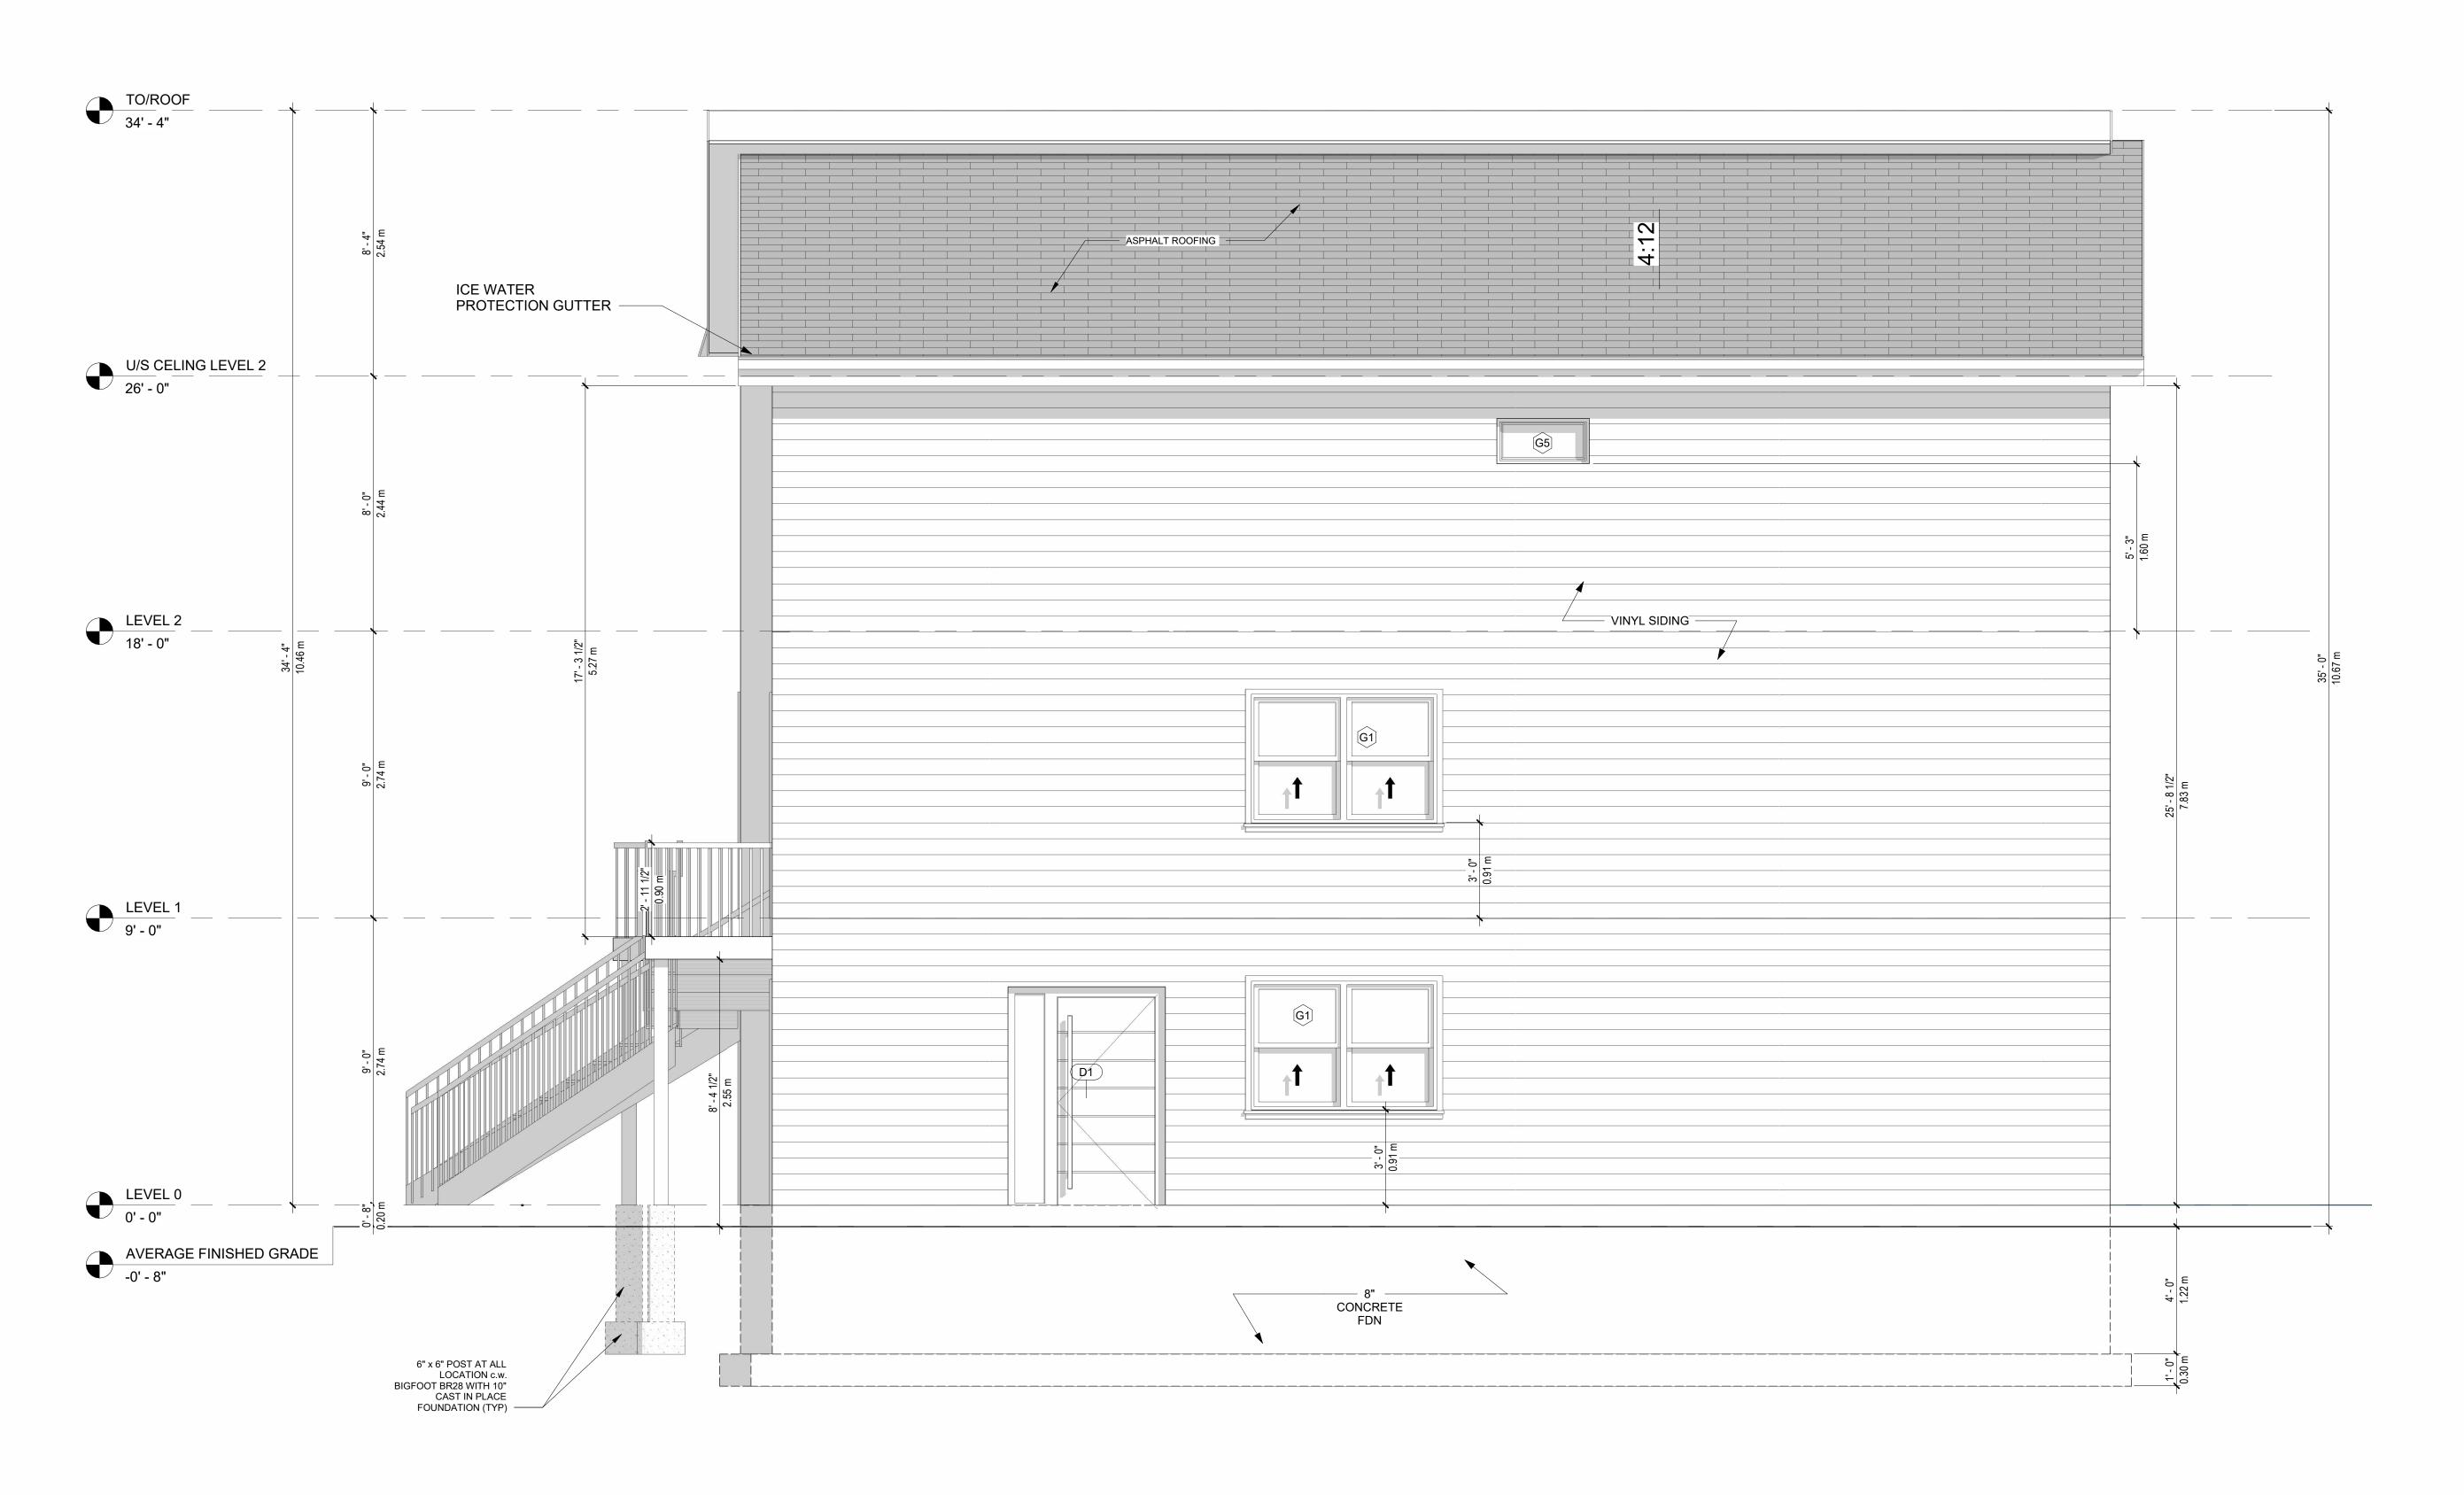

2 PROPOSED LEFT ELEVATION A202 3/8" = 1'-0"



"Where Imagination & Reality Collide"

GENERAL NOTES:

NOT FOR CONSTRUCTION

ALL DIMENSIONS TO BE VERIFIED ON SITE AND CONFIRMED BY CONTRACTOR.

DO NOT SCALE THIS DRAWING.

REV	DESCRIPTION	DATE
1	ISSUED FOR REVIEW	2023.03.1

ISSUED FOR BUILDING PERMIT


DRAWING TITLE:

PROPOSED WEST ELEVATION

PROJECT:

NEW TWO - FAMILY DWELLING

DRAWN BY:	VMZ
CHECKED BY:	MS
DATE:	2023.03.21
CLIENT:	DWG:
	4 000
SCALE:	A202
3/8" = 1'-0"	

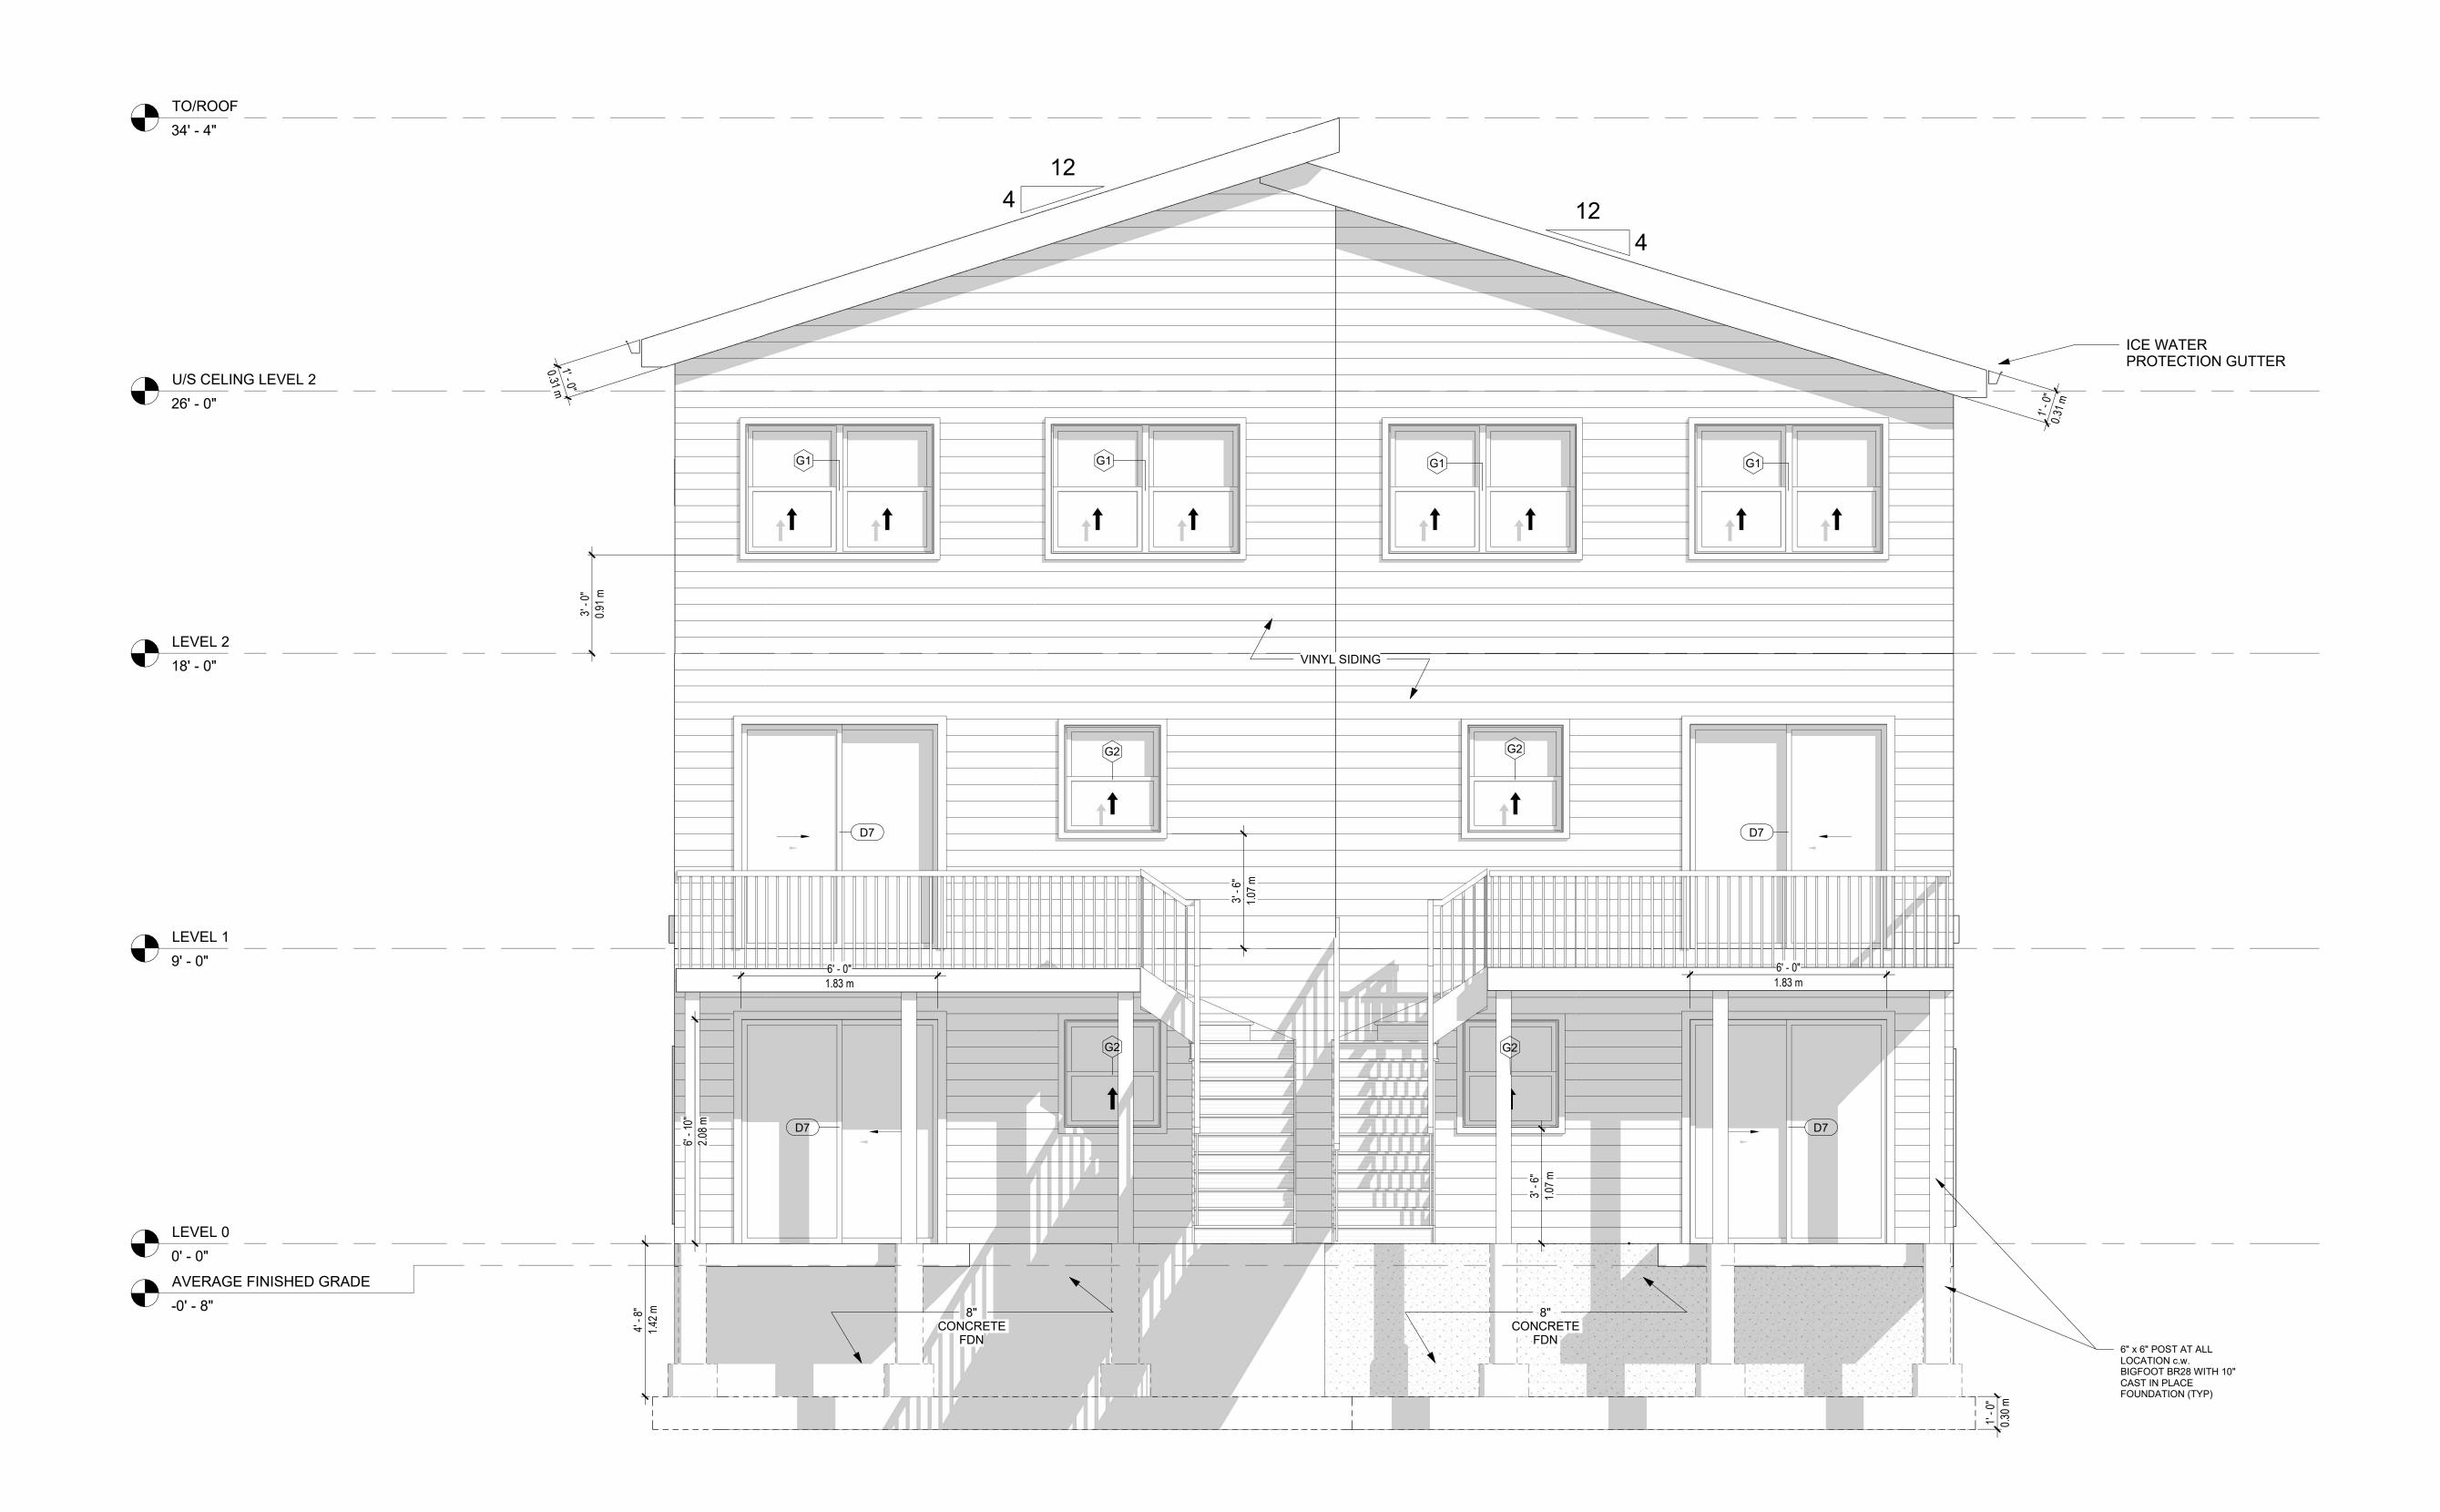




GENERAL NOTES:

NOT FOR CONSTRUCTION

ALL DIMENSIONS TO BE VERIFIED ON SITE AND CONFIRMED BY CONTRACTOR.

DO NOT SCALE THIS DRAWING.

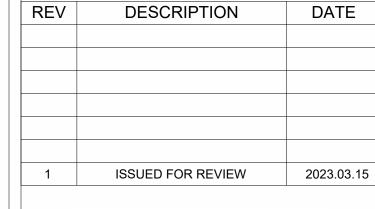

ISSUED FOR BUILDING PERMIT

DRAWING TITLE:

PROPOSED NORTH ELEVATION


PROJECT:

NEW TWO - FAMILY DWELLING

6 CLOVIS AVENUE, HALIFAX, NOVA SCOTIA, B3P 1J2

DRAWN BY:	VMZ
CHECKED BY:	MS
DATE:	2023.03.21
CLIENT:	DWG:
	4 000
SCALE:	A203
3/8" = 1'-0"	

1 PROPOSED REAR ELEVATION A203 3/8" = 1'-0"

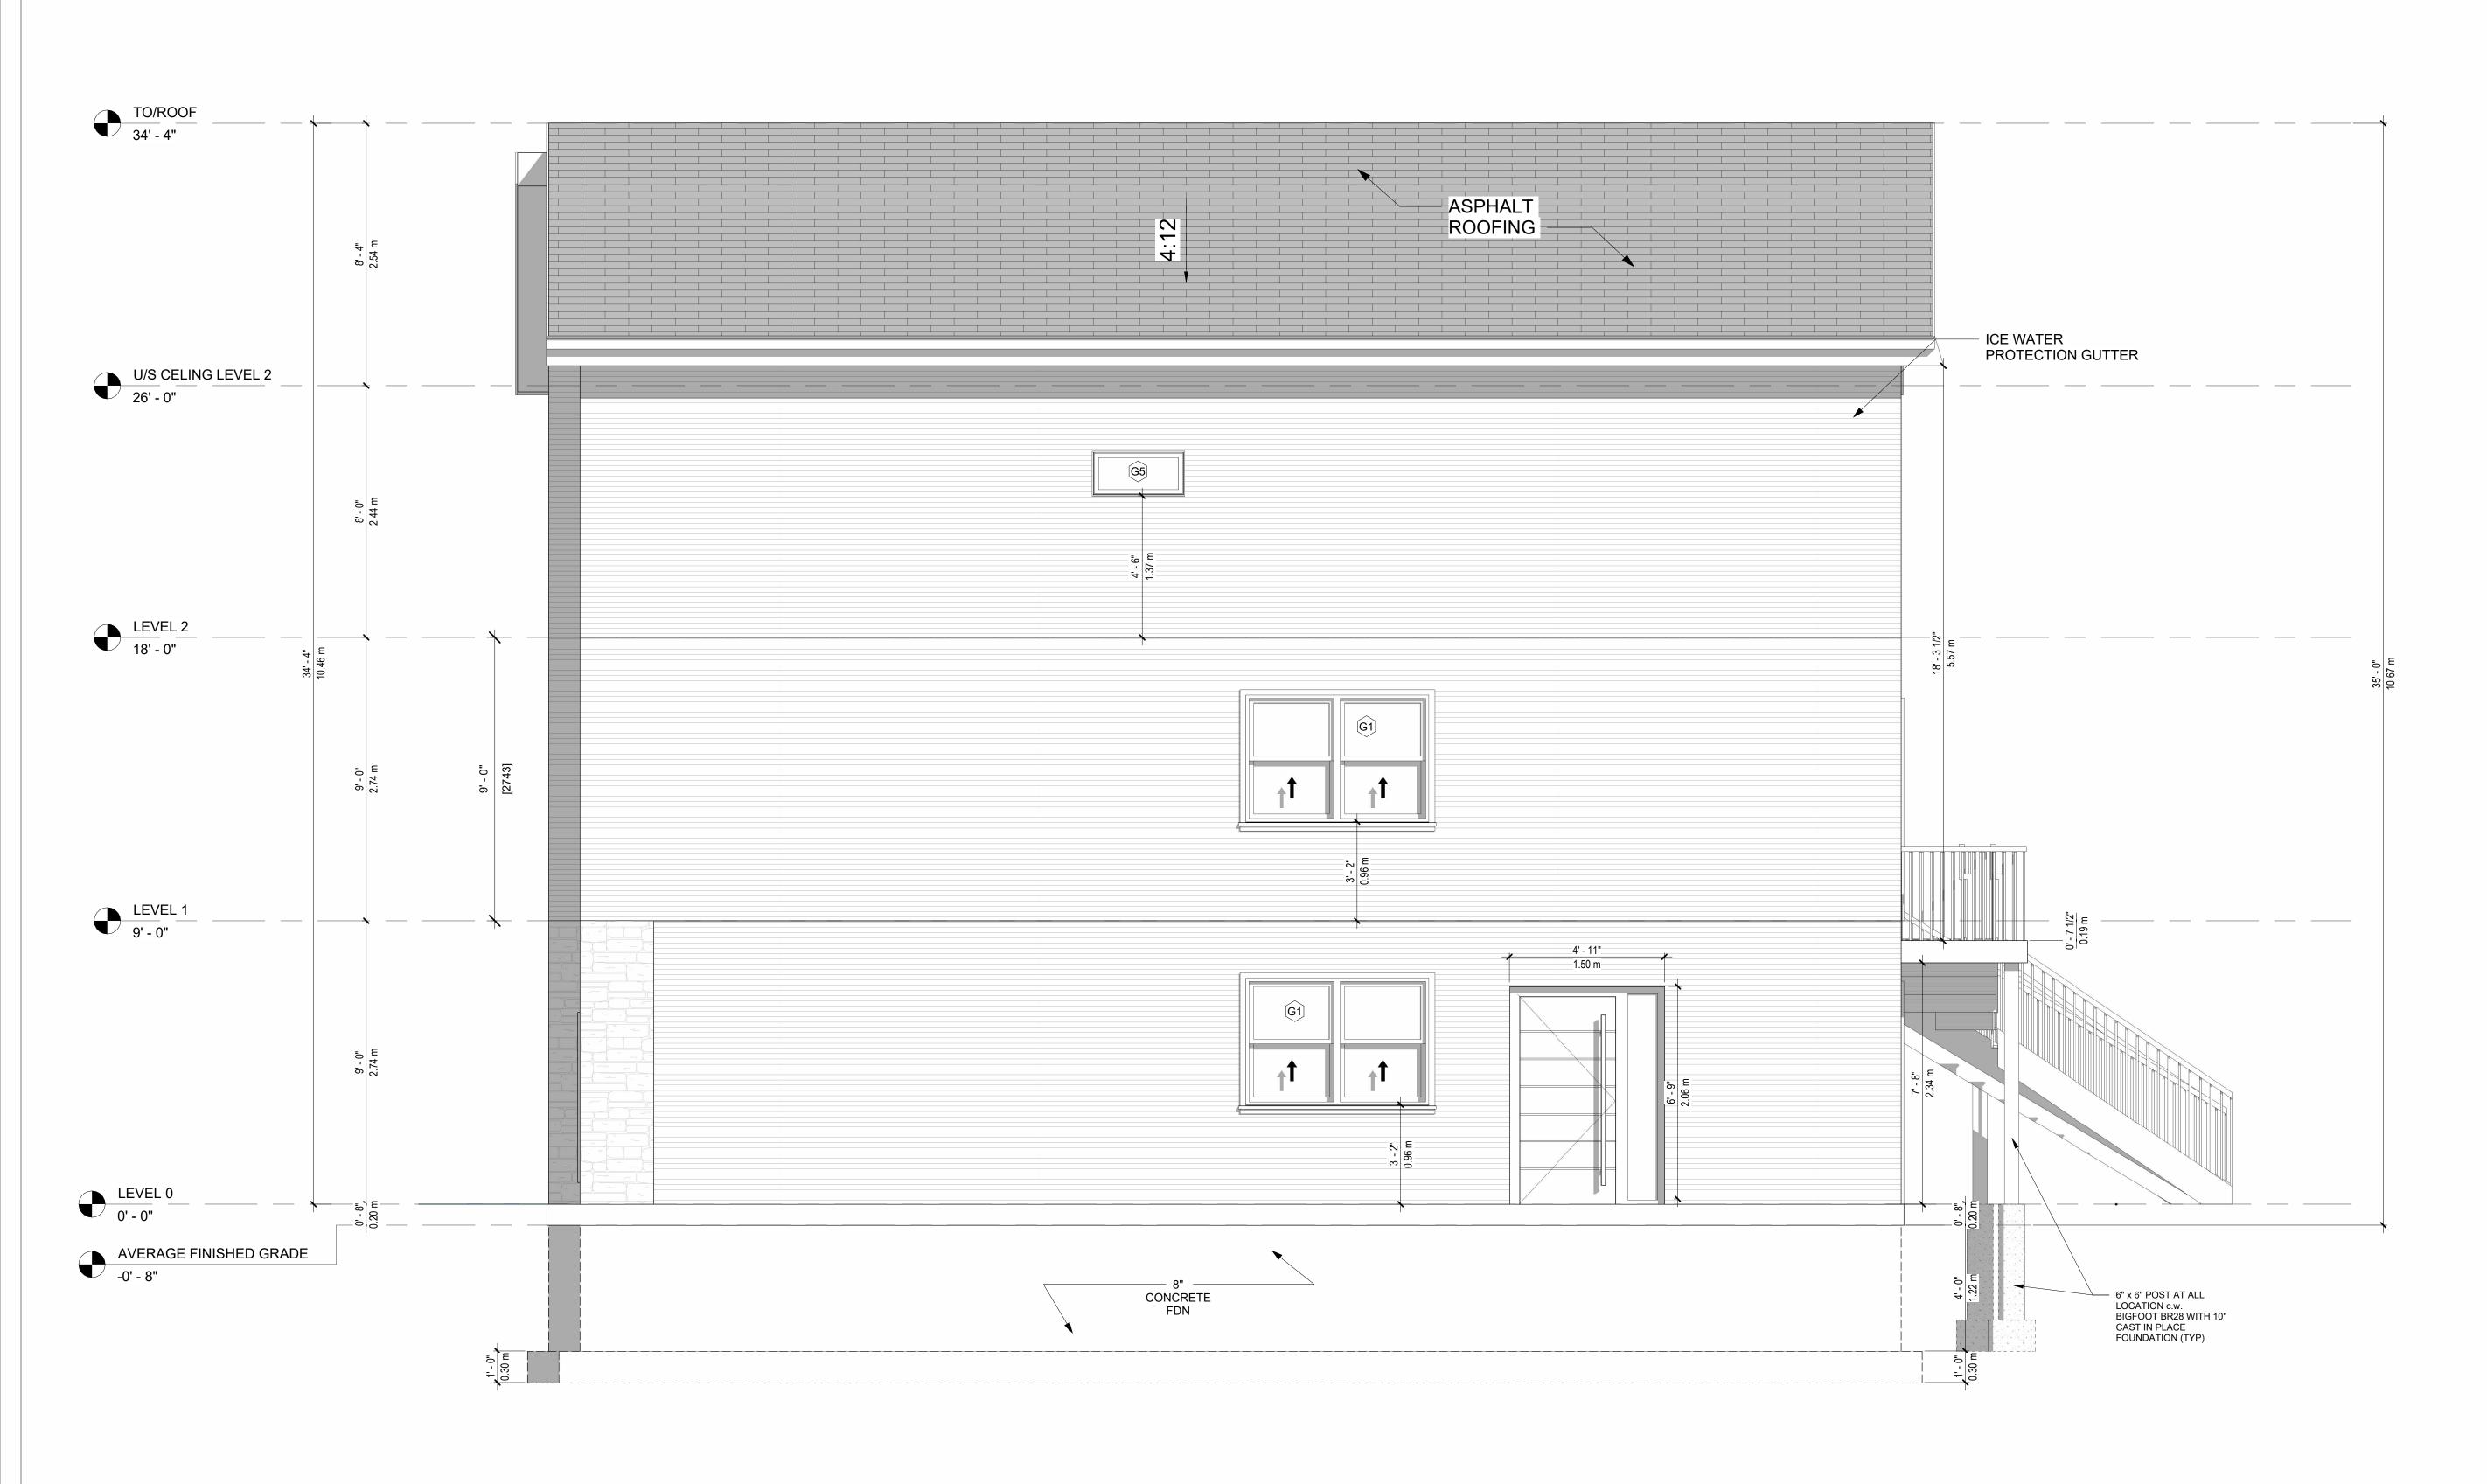



GENERAL NOTES:

NOT FOR CONSTRUCTION

ALL DIMENSIONS TO BE VERIFIED ON SITE AND CONFIRMED BY CONTRACTOR.

DO NOT SCALE THIS DRAWING.

1					
	REV	DESCRIPTION	DATE		
	1	ISSUED FOR REVIEW	2023.03.15		

ISSUED FOR BUILDING PERMIT

DRAWING TITLE:

PROPOSED EAST ELEVATION

PROJECT:

NEW TWO - FAMILY DWELLING

6 CLOVIS AVENUE, HALIFAX, NOVA SCOTIA, B3P 1J2


DRAWN BY:	VMZ
CHECKED BY:	MS
DATE:	2023.03.21
CLIENT:	DWG:
	4004
SCALE:	A204
3/8" = 1'-0"	

1 PROPOSED RIGHT ELEVATION
A204 3/8" = 1'-0"

FIRE RATED SCHEDULE:

W4a: 1H STC 51 (FIRE RATED WALL). SHADED IN DARK GREY

- 38X89MM STUDS SPACED 400MM OC
- 89MM THICK ABSORPTIVE MATERIAL
- RESILIENT METAL CHANNEL ON SIDE SPACED 400MM O.C.
- 2 LAYERS 15.9MM TYPE X GWB
- 1 LAYER 12.7MM GWB ON OTHER SIDE

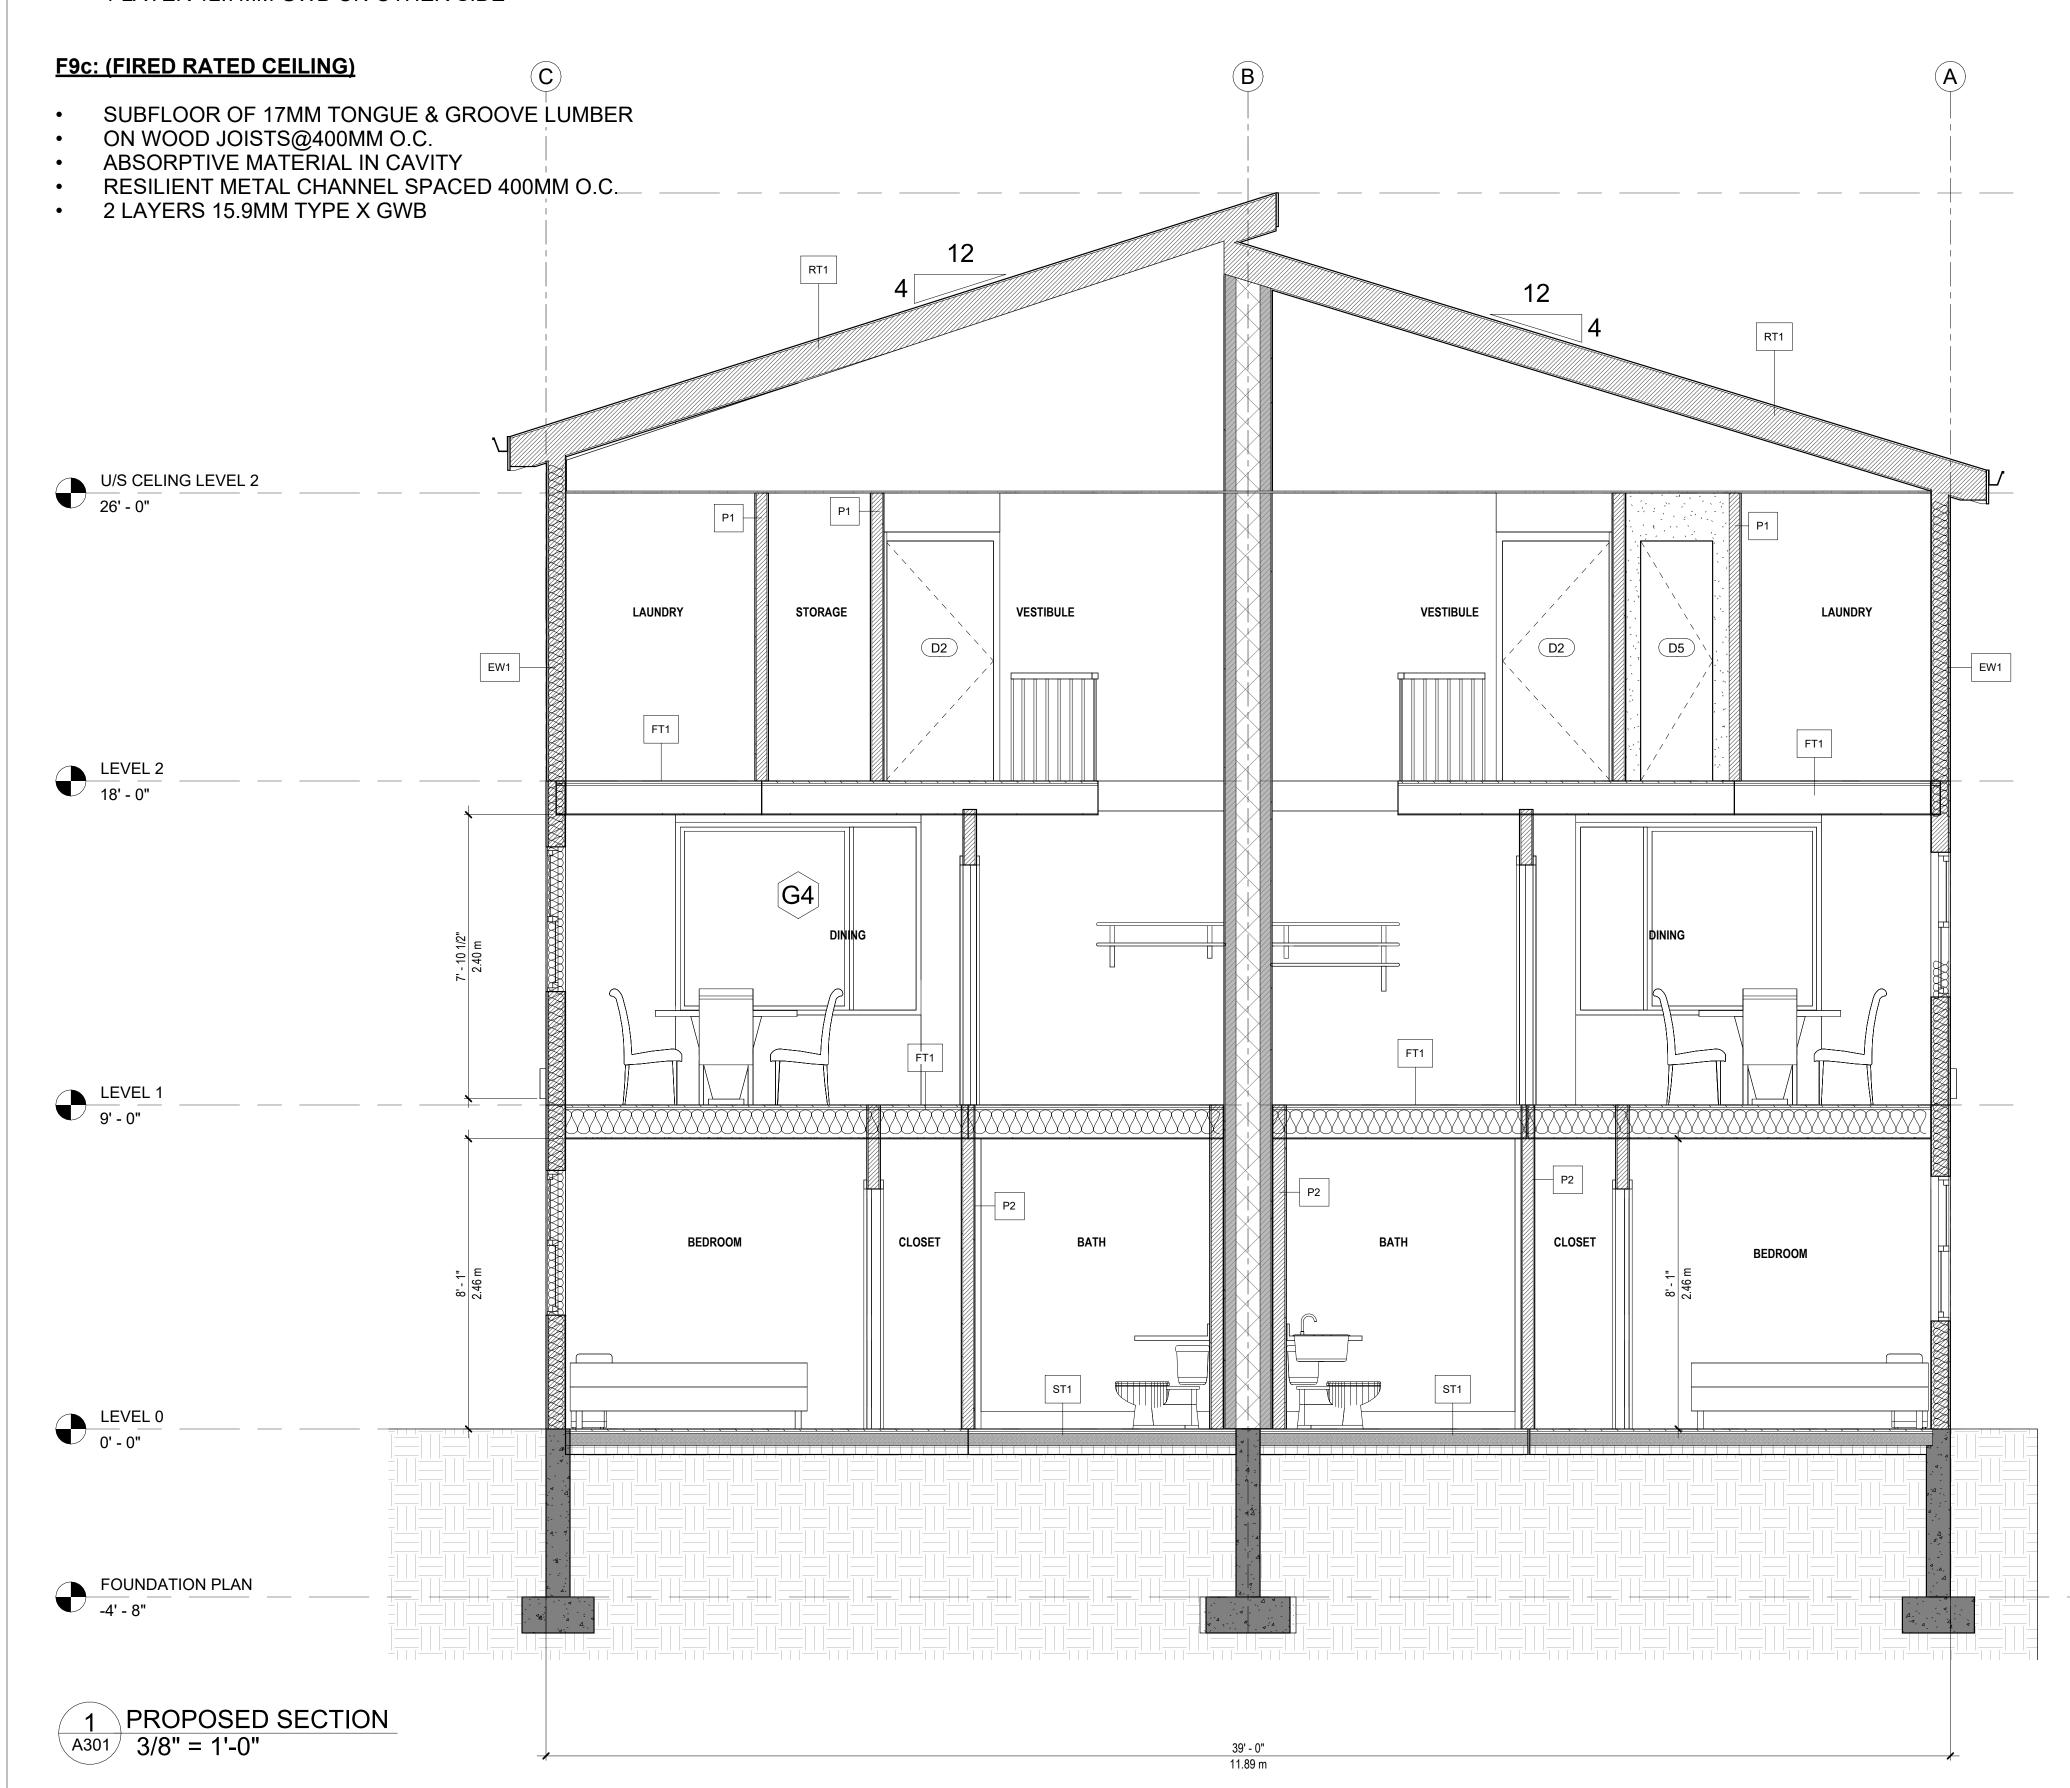

LEGEND:

EW1 EXTERIOR WALL

- SIDING SPECIFIED BY OWNER
- APPROVED AIR BARRIER
- 1/2" PLYWOOD SHEATHING 2" X 6" WOOD STUDS AT 16" O.C.
- 6" F.B. INSULATION (R24)
- 6 MIL POLY VAPOUR BARRIER (APPROVED)
- 1/2" GYPSUM BOARD, TAPED, SANDED AND PAINTED

P1 PARTITION TYPE

- 1/2" PLYWOOD, TAPED, SANDED AND PAINTED
 - 2" X 4" WOOD STUDS AT 16" O.C.
- 1/2" PLYWOOD, TAPED, SANDED AND PAINTED

P2 PARTITION TYPE (BATHROOM)

- 1/2" PLYWOOD, TAPED, SANDED AND PAINTED
- 2" X 6" WOOD STUDS AT 16" O.C.
- 1/2" PLYWOOD, TAPED, SANDED AND PAINTED

ST1 FINISHED FOUNDATION SLAB

- 4" REINFORCED CONCRETE SLAB
 - 6" X 6" WWM SHEETS
- 6 MIL POLY VAPOUR BARRIER (APPROVED)
- LAPPED AND SEALED
- 3" RIGID INSULATION (R14)
- 8" COMPACTED GRAVEL

FT1 FLOOR CONSTRUCTION 12"

- FLOOR FINISH AS SPECIFIED BY OWNER
- 3/4" PLYWOOD SUB-FLOOR
- 2" X 10" FLOOR JOIST
- JOIST 16" O.C.
- BLOCKING @16" O.C. 1/2" GYPSUM BOARD

RT1 ROOF ASSEMBLY

- ASPHALT SHINGLES (QUALITY SPECIFIED BY OWNER)
- UNDERLAYMENT
- ICE AND WATER SHIELD (EXTENDING TO MIN OF 2'6"
- BEYOND FACE OF EXTERIOR WALL)
- TAR PAPER (TO COVER ROOF)
- 15/32" SUPER ROOF SHEATHING
- ENGINEERED ROOF TRUSSES
- 12" F. B. INSULATION (R50)
- 1" X 4" STRAPING AT 16" O.C.
- 6 MIL POLY VAPOUR BARRIER (APPROVED)
- 1/2" GYPSON BOARD, TAPED, SANDED AND PAINTED

DECK FRAMING

- PT. 1"X4" DECK BOARDS
- 2X8 JOISTS @ 24" O.C.
- 2X8" LEDGER BOARD
- 3PLY 2X10 BEAM
- 6X6 PT. POST BIGFOOT BF28 WTH 10"



"Where Imagination & Reality Collide"

GENERAL NOTES:

NOT FOR CONSTRUCTION

ALL DIMENSIONS TO BE VERIFIED ON SITE AND CONFIRMED BY CONTRACTOR.

DO NOT SCALE THIS DRAWING.

	REV	DESCRIPTION	DATE	
	1	ISSUED FOR REVIEW	2023.03.15	

ISSUED FOR BUILDING PERMIT


DRAWING TITLE:

PROPOSED SECTION

PROJECT:

NEW TWO - FAMILY DWELLING

DRAWN BY:	VMZ
CHECKED BY:	MS
DATE:	2023.03.2
CLIENT:	DWG:
	A 004
SCALE:	A301
3/8" = 1'-0"	

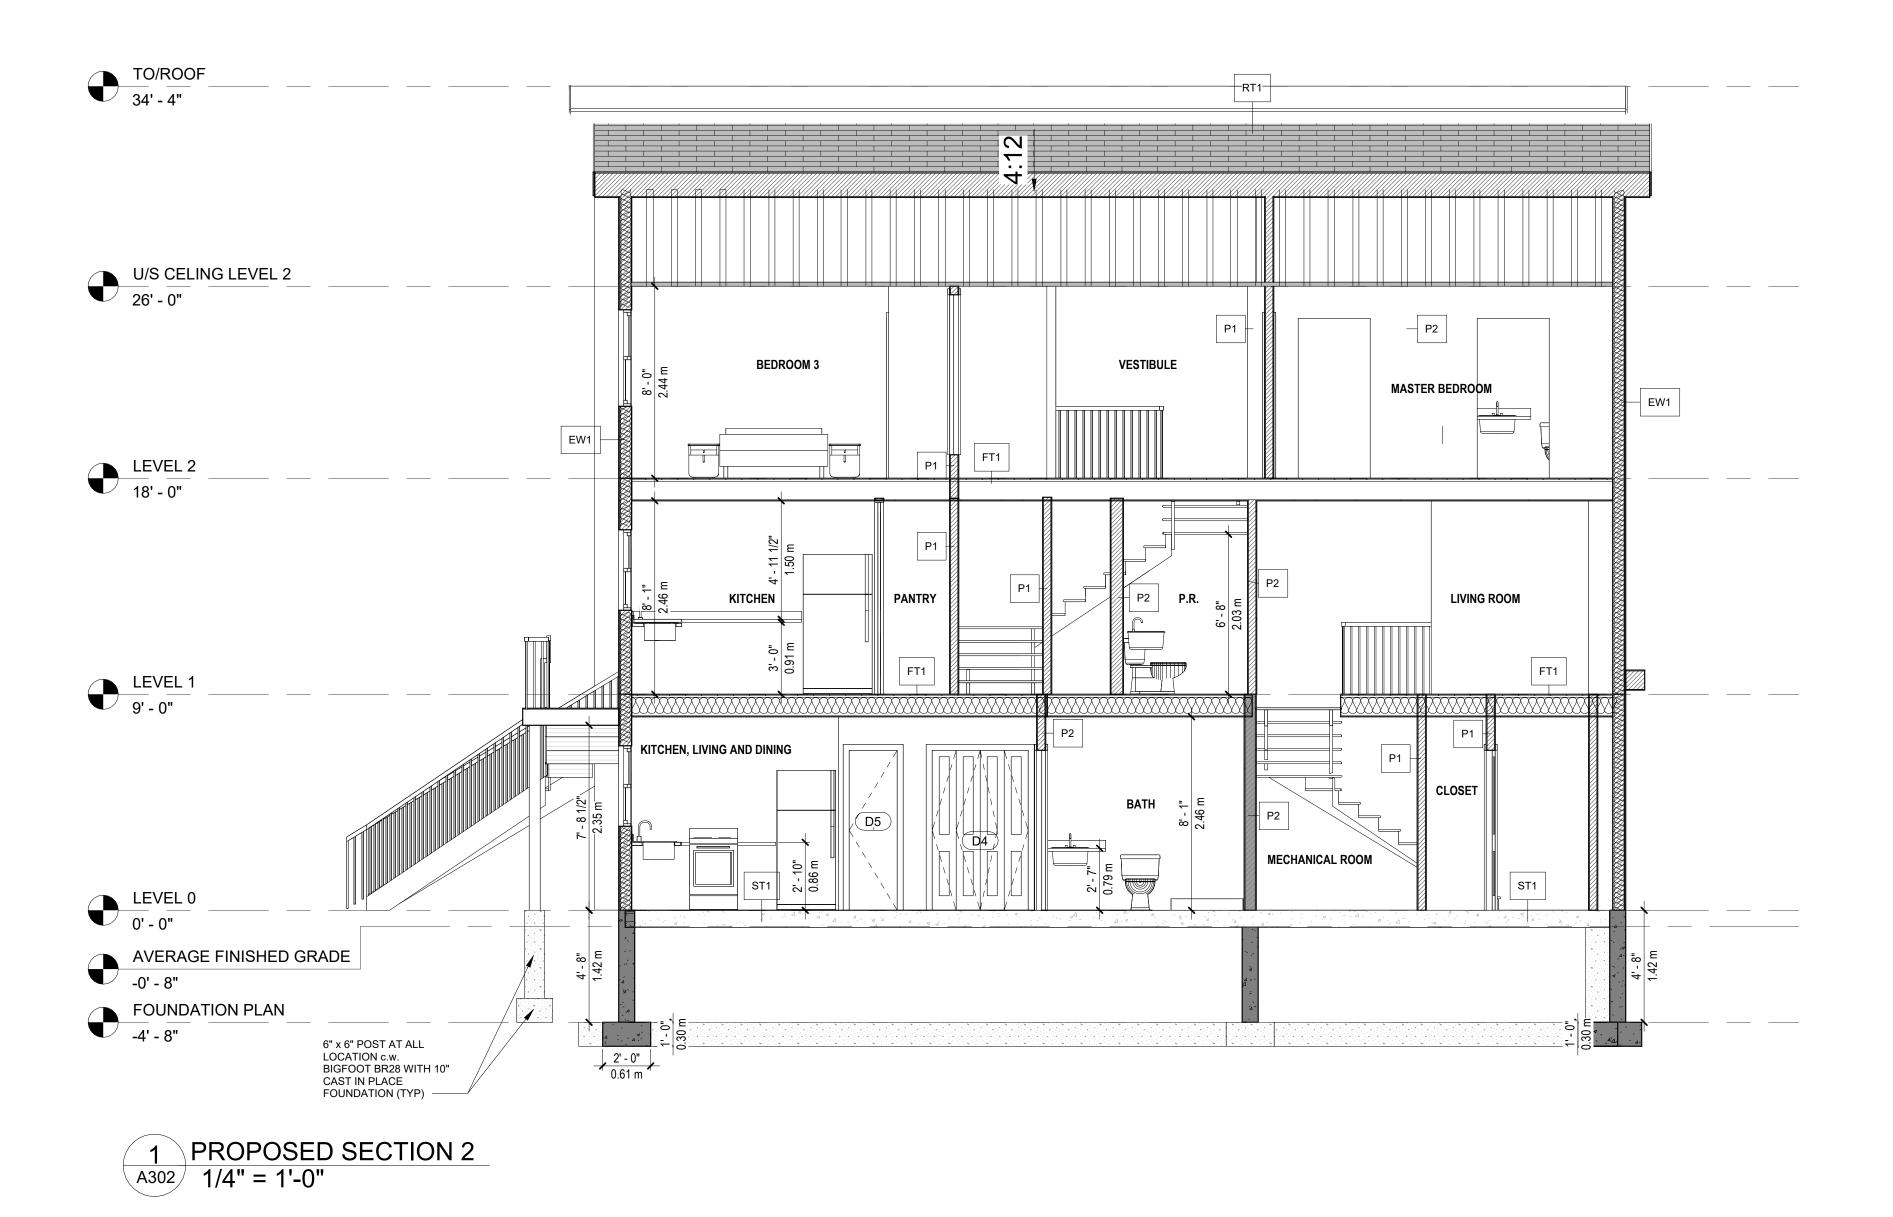

FIRE RATED SCHEDULE:

W4a: 1H STC 51 (FIRE RATED WALL). SHADED IN DARK GREY

- 38X89MM STUDS SPACED 400MM OC
- 89MM THICK ABSORPTIVE MATERIAL
- RESILIENT METAL CHANNEL ON SIDE SPACED 400MM O.C.
- 2 LAYERS 15.9MM TYPE X GWB
- 1 LAYER 12.7MM GWB ON OTHER SIDE

F9c: (FIRED RATED CEILING)

- SUBFLOOR OF 17MM TONGUE & GROOVE LUMBER
- ON WOOD JOISTS@400MM O.C.
- ABSORPTIVE MATERIAL IN CAVITY
- RESILIENT METAL CHANNEL SPACED 400MM O.C.
- 2 LAYERS 15.9MM TYPE X GWB

LEGEND:

EW1 EXTERIOR WALL

- SIDING SPECIFIED BY OWNER
- APPROVED AIR BARRIER
- 1/2" PLYWOOD SHEATHING
- 2" X 6" WOOD STUDS AT 16" O.C.
 - 6" F.B. INSULATION (R24)
- 6 MIL POLY VAPOUR BARRIER (APPROVED)
- 1/2" GYPSUM BOARD, TAPED, SANDED AND PAINTED

P1 PARTITION TYPE

- 1/2" PLYWOOD, TAPED, SANDED AND PAINTED
- 2" X 4" WOOD STUDS AT 16" O.C.
- 1/2" PLYWOOD, TAPED, SANDED AND PAINTED

P2 PARTITION TYPE (BATHROOM)

- 1/2" PLYWOOD, TAPED, SANDED AND PAINTED
- 2" X 6" WOOD STUDS AT 16" O.C.
- 1/2" PLYWOOD, TAPED, SANDED AND PAINTED

ST1 FINISHED FOUNDATION SLAB

- 4" REINFORCED CONCRETE SLAB
- 6" X 6" WWM SHEETS
- 6 MIL POLY VAPOUR BARRIER (APPROVED)
- LAPPED AND SEALED
- 3" RIGID INSULATION (R14)
- 8" COMPACTED GRAVEL

FT1 FLOOR CONSTRUCTION 12"

- FLOOR FINISH AS SPECIFIED BY OWNER
- 3/4" PLYWOOD SUB-FLOOR
- 2" X 10" FLOOR JOIST
- JOIST 16" O.C.
- BLOCKING @16" O.C.1/2" GYPSUM BOARD
- 1/2 011 0011 20/ 11 12

RT1 ROOF ASSEMBLY

- ASPHALT SHINGLES (QUALITY SPECIFIED BY OWNER)
- UNDERLAYMENT
- ICE AND WATER SHIELD (EXTENDING TO MIN OF 2'6"

 PENCALD FACE OF EXTERIOR WALL)
- BEYOND FACE OF EXTERIOR WALL)
- TAR PAPER (TO COVER ROOF)
- 15/32" SUPER ROOF SHEATHING
- ENGINEERED ROOF TRUSSES
- 12" F. B. INSULATION (R50)
- 1" X 4" STRAPING AT 16" O.C.
- 6 MIL POLY VAPOUR BARRIER (APPROVED)
- 1/2" GYPSON BOARD, TAPED, SANDED AND PAINTED

DECK FRAMING

- PT. 1"X4" DECK BOARDS
- 2X8 JOISTS @ 24" O.C.
- 2X8" LEDGER BOARD
- 3PLY 2X10 BEAM
- 6X6 PT. POST
- BIGFOOT BF28 WTH 10"



"Where Imagination & Reality Collide"

GENERAL NOTES:

NOT FOR CONSTRUCTION

ALL DIMENSIONS TO BE VERIFIED ON SITE AND CONFIRMED BY CONTRACTOR.

DO NOT SCALE THIS DRAWING.

REV	DESCRIPTION	DATE
1	ISSUED FOR REVIEW	2023.03.15

ISSUED FOR BUILDING PERMIT

DRAWING TITLE:


PROPOSED SECTION 2


PROJECT:


NEW TWO - FAMILY DWELLING

DRAWN BY:	VMZ
CHECKED BY:	MS
DATE:	2023.03.2
CLIENT:	DWG:
	A 200
SCALE:	A302
1/4" = 1'-0"	

		WINDOW SCH	EDULE
WINDOW	ROUGH WITH	ROUGH HEIGHT	LEVEL
G1			
G1 G1	5' - 10 1/2"	4' - 0 3/4"	GROUND LEVEL
G1	5' - 10 1/2"	4' - 0 3/4"	GROUND LEVEL
G1	5' - 10 1/2"	4' - 0 3/4"	LEVEL 1
G1	5' - 10 1/2"	4' - 0 3/4"	LEVEL 1
G1	5' - 10 1/2"	4' - 0 3/4"	LEVEL 2
G1	5' - 10 1/2"	4' - 0 3/4"	LEVEL 2
G1	5' - 10 1/2"	4' - 0 3/4"	LEVEL 2
G1	5' - 10 1/2"	4' - 0 3/4"	LEVEL 2
G1: 8]	
G2			
G2	3' - 0 1/2"	3' - 4 3/4"	GROUND LEVEL
G2	3' - 0 1/2"	3' - 4 3/4"	GROUND LEVEL
G2	3' - 0 1/2"	3' - 4 3/4"	LEVEL 1
G2	3' - 0 1/2"	3' - 4 3/4"	LEVEL 1
G2: 4			
G3			
G3	2' - 0 3/4"	4' - 0 3/4"	LEVEL 1
G3	2' - 0 3/4"	4' - 0 3/4"	LEVEL 1
• •			
G3	2' - 0 3/4"	4' - 0 3/4"	LEVEL 2
	2' - 0 3/4" 2' - 0 3/4"	4' - 0 3/4" 4' - 0 3/4"	LEVEL 2 LEVEL 2
G3			
G3 G3 G3: 4			
G3 G3 G3: 4			
G3 G3 G3: 4 G4	2' - 0 3/4"	4' - 0 3/4"	LEVEL 2
G3 G3 G3: 4 G4	2' - 0 3/4" 6' - 10 1/2"	4' - 0 3/4" 5' - 4 3/4"	LEVEL 2 LEVEL 1
G3 G3: 4 G4 G4 G4 G4: 2	2' - 0 3/4" 6' - 10 1/2"	4' - 0 3/4" 5' - 4 3/4"	LEVEL 2 LEVEL 1
G3 G3: 4 G4 G4 G4 G4: 2	2' - 0 3/4" 6' - 10 1/2"	4' - 0 3/4" 5' - 4 3/4"	LEVEL 2 LEVEL 1
G3 G3: 4 G4 G4 G4: 2 G5	2' - 0 3/4" 6' - 10 1/2" 6' - 10 1/2"	4' - 0 3/4" 5' - 4 3/4" 5' - 4 3/4"	LEVEL 2 LEVEL 1 LEVEL 1
G3 G3: 4 G4 G4 G4 G4: 2 G5 G5	2' - 0 3/4" 6' - 10 1/2" 6' - 10 1/2" 2' - 11 1/2"	4' - 0 3/4" 5' - 4 3/4" 5' - 4 3/4" 1' - 5 1/2"	LEVEL 1 LEVEL 1 LEVEL 2
G3 G3: 4 G4 G4 G4: 2 G5 G5 G5 G5: 2	2' - 0 3/4" 6' - 10 1/2" 6' - 10 1/2" 2' - 11 1/2"	4' - 0 3/4" 5' - 4 3/4" 5' - 4 3/4" 1' - 5 1/2"	LEVEL 1 LEVEL 1 LEVEL 2
G3 G3: 4 G4 G4 G4: 2 G5	2' - 0 3/4" 6' - 10 1/2" 6' - 10 1/2" 2' - 11 1/2"	4' - 0 3/4" 5' - 4 3/4" 5' - 4 3/4" 1' - 5 1/2"	LEVEL 1 LEVEL 1 LEVEL 2

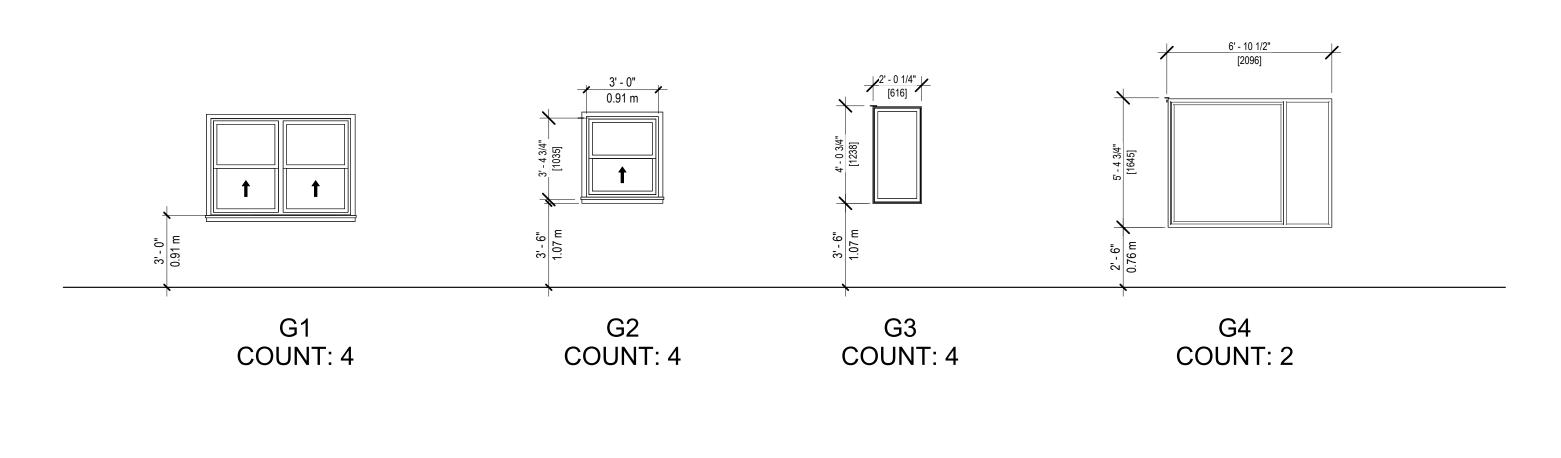

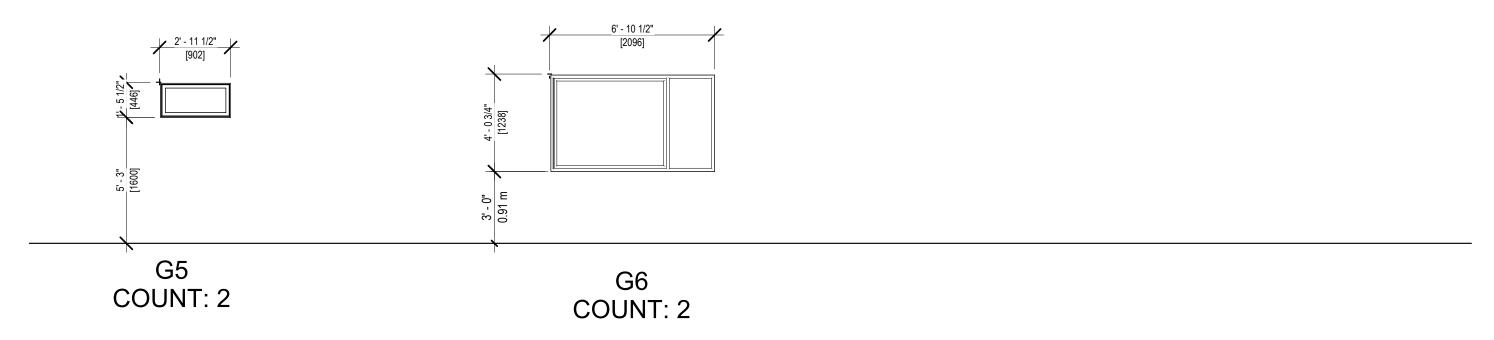

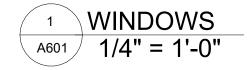

WINDOW AND DOORS NOTES:

- WINDOWS AND DOORS STYLE AND FINISH TO BE
- DETERMINED BY THE OWNER

 WINDOWS DIMENSIONS ARE RSO

 DOORS DIMESIONS ARE REFERED TO DOOR LEAF
- ALL SITE DIMENSIONS AND SILL HEIGHTS TO BE VERIFIED ON SITE BY GENERAL CONTRACTOR



GENERAL NOTES:

NOT FOR CONSTRUCTION

ALL DIMENSIONS TO BE VERIFIED ON SITE AND CONFIRMED BY CONTRACTOR.

DO NOT SCALE THIS DRAWING.

REV	DESCRIPTION	DATE
1	ISSUED FOR REVIEW	2023.03.15
		_

ISSUED FOR BUILDING PERMIT

DRAWING TITLE:


WINDOW SCHEDULE

PROJECT:

NEW TWO - FAMILY DWELLING

DRAWN BY:	VMZ
CHECKED BY:	MS
DATE:	2023.03.2
CLIENT:	DWG:
	1004
SCALE:	A601
1/4" = 1'-0"	
	I

DOOR SCHEDULE				
DOOR	<u>LEVEL</u>	WIDTH	HEIGHT	DESCRIPTION
D1	LEVEL 0	4' - 11"	7' - 0"	EXTERIOR DOOR
D1	LEVEL 0	4' - 11"	7' - 0"	EXTERIOR DOOR
D1	LEVEL 0	4' - 11"	7' - 0"	EXTERIOR DOOR
D1	LEVEL 0	4' - 11"	7' - 0"	EXTERIOR DOOR
01: 4				
D2	LEVEL 0	3' - 0"	6' - 8"	INTERIOR DOOR
D2	LEVEL 0	3' - 0"	6' - 8"	INTERIOR DOOR
D2	LEVEL 0	3' - 0"	6' - 8"	INTERIOR DOOR
D2	LEVEL 0	3' - 0"	6' - 8"	INTERIOR DOOR
D2	LEVEL 0	3' - 0"	6' - 8"	INTERIOR DOOR
D2	LEVEL 0	3' - 0"	6' - 8"	INTERIOR DOOR
D2	LEVEL 0	3' - 0"	6' - 8"	INTERIOR DOOR
D2	LEVEL 0	3' - 0"	6' - 8"	INTERIOR DOOR
D2	LEVEL 1	3' - 0"	6' - 8"	INTERIOR DOOR
D2	LEVEL 1	3' - 0"	6' - 8"	INTERIOR DOOR
D2	LEVEL 2	3' - 0"	6' - 8"	INTERIOR DOOR
D2	LEVEL 2	3' - 0"	6' - 8"	INTERIOR DOOR
02: 22				
D3	LEVEL 0	2' - 6"	6' - 8"	CLOSET
D3	LEVEL 0	2' - 6"	6' - 8"	CLOSET
03: 2		1	•	•
D4	LEVEL 0	4' - 0"	6' - 8"	CLOSET
D4	LEVEL 0	4' - 0"	6' - 8"	CLOSET
D4	LEVEL 0	4' - 0"	6' - 8"	LAUNDRY

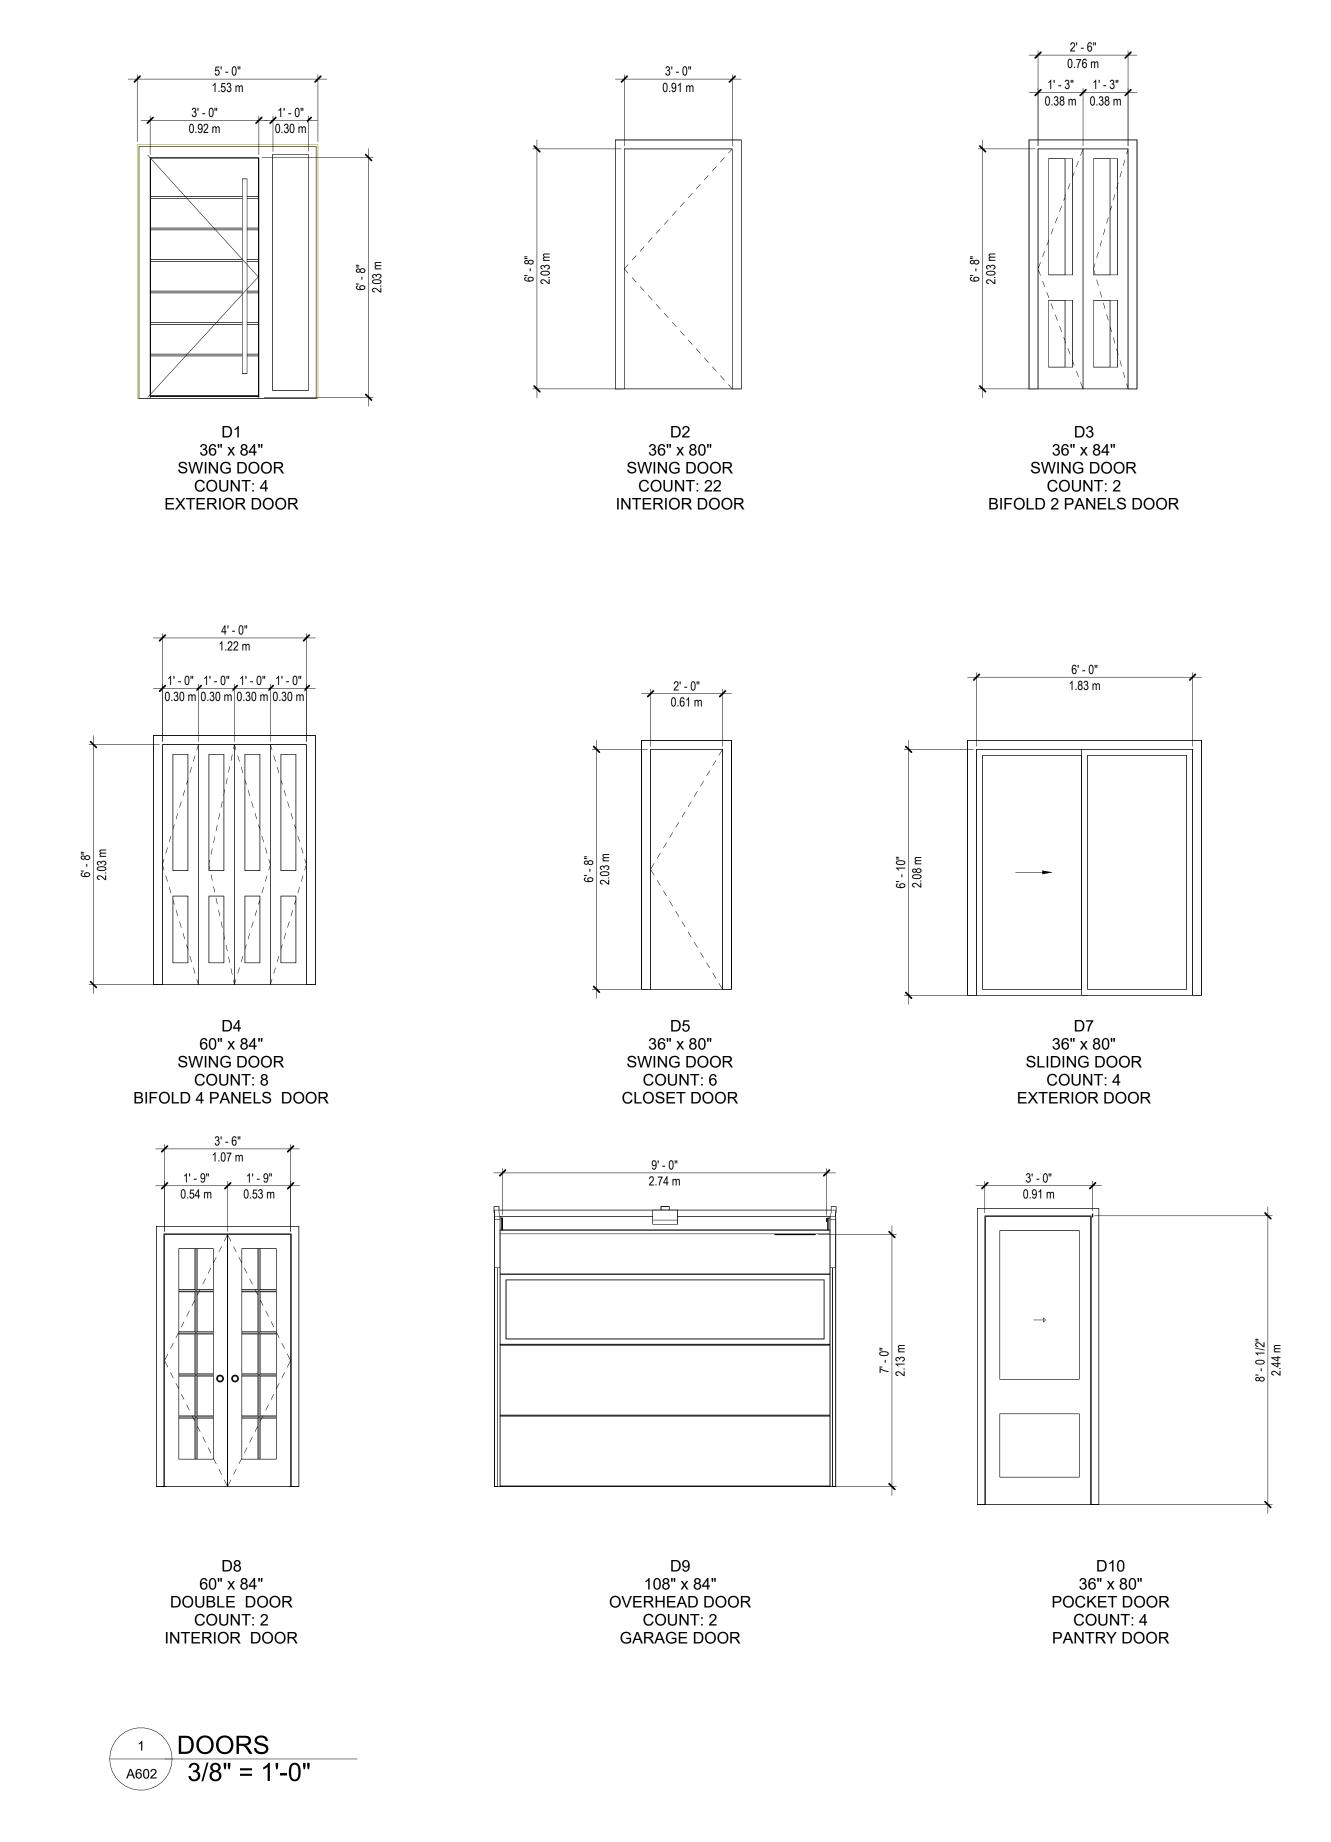

DOORS NOTES:

- DOORS STYLE AND FINISHES TO BE DETERMINED BY THE OWNER
- DOORS DIMESIONS ARE REFERED TO DOOR LEAF
- ALL SITE DIMENSIONS AND SILL HEIGHTS TO BE VERIFIED ON SITE BY GENERAL CONTRACTOR



"Where Imagination & Reality Collide"

GENERAL NOTES:

NOT FOR CONSTRUCTION

ALL DIMENSIONS TO BE VERIFIED ON SITE AND CONFIRMED BY CONTRACTOR.

DO NOT SCALE THIS DRAWING.

REV	DESCRIPTION	DATE
1	ISSUED FOR REVIEW	2023.03.15

ISSUED FOR BUILDING PERMIT

DRAWING TITLE:

DOOR SCHEDULE

PROJECT:

NEW TWO - FAMILY DWELLING

DRAWN BY:	VMZ
CHECKED BY:	MS
DATE:	2023.03.21
CLIENT:	DWG:
	4 000
SCALE:	A602
0.4011 41.011	
3/8" = 1'-0"	







360 CAD SERVICES INC.
"Where Imagination & Reality Collide"

GENERAL NOTES:

NOT FOR CONSTRUCTION

ALL DIMENSIONS TO BE VERIFIED ON SITE AND CONFIRMED BY CONTRACTOR.

DO NOT SCALE THIS DRAWING.

REV	DESCRIPTION	DATE
1	ISSUED FOR REVIEW	2023.03.15

ISSUED FOR BUILDING PERMIT

DRAWING TITLE:

3D VIEWS

PROJECT:

NEW TWO - FAMILY DWELLING

3.03.2
MS
VMZ